

# CITY OF SHELBYVILLE

Adam M. Rude  
Director



Allan Henderson  
Deputy Director

## PLAN COMMISSION

**MEETING DATE: 6/24/2019**

Case Number & Name:	PC 2019-10; Parks and Recreation Maintenance Facility			
Petitioner's Name:	Shelbyville Parks Board			
Owner's Name:	Shelbyville Parks and Recreation			
Petitioner's Representative:	Jenny Meltzer			
Address of Property:	1021 Morris Ave.			
Subject Property Zoning Classification:	Parks and Open Space			
Comprehensive Future Land use:	Parks and Recreation			
	<b>North</b>	<b>East</b>	<b>South</b>	<b>West</b>
Surrounding Properties' Zoning Classifications:	Single Family Residential	Business Highway	Business Highway	Single Family Residential
Surrounding Properties' Comprehensive Future Land Use	Commercial	Conservation	Gateway/Mixed Use	Single Family Residential
History:	The site is the location of Blue River Memorial Park. The Park Board has slowly expanded recreational amenities at this facility and requires a maintenance building to continue to provide a high level of service.			
Vicinity Map:				
Action Requested:	Site Development Plan approval for a new maintenance building.			

1. This petition is to construct a maintenance building in Blue River Memorial Park. The building will be located south of the ball fields and be accessed by an asphalt drive from the existing parking lot. The maintenance facility will be approximately 6,000 feet with a small outdoor storage area to the south of the building.
2. The Zoning Ordinance (Section 9.05 (F) (5)) requires the Plan Commission make Findings of Fact that the Site Development Plan:
  - a. **Is consistent with the City of Shelbyville Comprehensive Plan;**  
The planning staff has determined the subject petition is consistent with the City's Comprehensive Plan. The site has always been used for recreation and based on the future land use map will remain in parks and open space.
  - b. **Meets the Technical Review Committee's expectations for best practices and quality design;**  
The Technical Review Committee reviewed the site development plan against their applicable standards. All members in attendance at the Technical Review Committee meeting on May 28, 2019 provided guidance on ensuring the site plan and building would meet the City of Shelbyville requirements. Comment sheets are attached for reference.
  - c. **Satisfies the applicable requirements of Article 2: Zoning Districts;**  
The PK – Parks and Open Space zoning district allows for recreational use and supporting accessory structures.
  - d. **Satisfies the applicable requirements of Article 5: Development Standards;**

**Entrance and Driveway Standards – UDO 5.15**

5.15 requires access roads be at least twenty (20) feet wide, but not exceed thirty-six (36) feet in over-all width. In addition, access roads shall consist of asphalt, concrete, pavers, or other durable paving material. The proposed access drive is twenty-five (25) feet wide and will be asphalt. The entrance and drive standards are being met.

**Environmental Standards UDO 5.16**

5.16 requires any part or portion of a non-farm parcel that is not used for structures, loading or parking spaces, sidewalks, or accessory uses shall be landscaped or left in a natural state that complies with the applicable weed and nuisance ordinances of the City of Shelbyville. If landscaped, it shall be planted with an all season ground cover and with trees and shrubs in accordance with the requirements of this Ordinance and in keeping with natural surroundings. No landscaping plans has been submitted. Environmental standards are not being met.

**Fence, Hedge and Wall Standards – UDO 5.20**

5.20 requires fences, hedges, and walls not to exceed eight (8) feet in height in any side or rear yard and shall not extend past the front facade of the primary structure. There will be a split-face block wall with gates enclosing the outdoor storage area. Drawing C101 indicates

that a six (6) foot high split face block fence with two eight (8) foot wide gates will be installed at the drive entrance on the back of the building.

**Height Standards – UDO 5.23**

5.23 limits the height of primary structures to (35') thirty five feet in the Parks and Open Space District. The height of the building will be 18 feet.

**Landscaping Standards – UDO 5.32, 5.35, 5.36.**

5.32 requires foundation plantings to be planted along all four (4) sides of the foundation excluding drive-throughs, loading docks, and the front door. 5.35 requires parking lots to be separated from all planned public rights-of-way (consistent with the Shelbyville Official Thoroughfare Plan) by a landscaping area that is a minimum of ten (10) feet in width. Lots include parking spaces, interior drives, and loading areas. 5.36 requires landscape materials consistent with the requirements of the Unified Development Ordinance are required when an improvement location permit is filed for a new primary structure. Landscaping plans have not been provided.

**Lighting Standards – UDO 5.38**

UDO 5.38 requires lighting fixtures on facades to be located, aimed, and shielded so that light is directed only onto the building façade. Drawing C104 indicates the Wall Pak lighting will be places on each of the four (4) facades and shall be 90 degree cut-off fixture directed downward.

**Setback Standards – UDO 5.55**

5.55 requires a minimum front yard setback of 30 feet for primary structures when adjacent to a collector road and side yard and rear yard setbacks of 10 feet. The setback standards are being met.

**e. Satisfies the applicable requirements of Article 6: Design Standards**

Article 6: Design Standards provides the standards for all subdivisions and generally apply to the construction of public improvements. Article 6: Design Standards do not apply to the construction of a maintenance facility in the PK – Parks and Open Space district.

**f. Satisfies any other applicable provisions of the Unified Development Ordinance.**

At this time, all other applicable provisions of the Unified Development Ordinance appear to be satisfied by the submitted site plans.

**STAFF RECOMMENDATION: Approval, subject to the following condition:**

1. The spirit and intent of the Landscape Standards are met with foundation and parking lot standard plantings.

## Site Development Plan: PC 2019-10; Parks and Recreation Maintenance Facility

### Staff Prepared

Motion:

(I) would like to make a motion to approve the site development plan as presented to this body, with the conditions outlined in the planning staff's report, pursuant to the planning staff's report and Findings of Fact.

1. ☐ The site development plan is consistent with the *City of Shelbyville Comprehensive Plan* as outlined in the planning staff's report.  
☐ The site development plan is **not** consistent with the *City of Shelbyville Comprehensive Plan*, as outlined in the planning staff's report.
2. ☐ The site development plan meets the Technical Review Committee's expectations for best practices and quality design, as outlined in the planning staff's report, as outlined in the planning staff's report.  
☐ The site development plan **does not** meet the Technical Review Committee's expectations for best practices and quality design, as outlined in the planning staff's report, as outlined in the planning staff's report
3. ☐ The site development plan satisfies the applicable requirements of Article 2: *Zoning Districts*, as outlined in the planning staff's report.  
☐ The site development plan **does not** satisfy the applicable requirements of Article 2: *Zoning Districts*, as outlined in the planning staff's report.
4. ☐ The site development plan satisfies the applicable requirements of Article 5: *Development Standards*, as outlined in the planning staff's report.  
☐ The site development plan **does not** satisfy the applicable requirements of Article 5: *Development Standards*, as outlined in the planning staff's report.
5. ☐ The site development plan satisfies the applicable requirements of Article 6: *Design Standards*, as outlined in the planning staff's report.  
☐ The site development plan **does not** satisfy the applicable requirements of Article 6: *Design Standards*, as outlined in the planning staff's report.
6. ☐ This site development plan satisfies all other applicable provision of the *Unified Development Ordinance*, as outlined by the planning staff's report.  
☐ The site development plan **does not** satisfy all other applicable provision of the *Unified Development Ordinance*, as outlined in the planning staff's report.

Additional Conditions Imposed by the Shelbyville Plan Commission:

- 1.
- 2.

Shelbyville Plan Commission

By: \_\_\_\_\_

Chairperson

Attest: \_\_\_\_\_

Secretary




BUILDING PLANS FOR:

SHELBYVILLE PARKS & REC. DEPT. - MAINTENANCE BUILDING

BLUE RIVER PARK, 1021 MORRIS AVE.

SHELBYVILLE, IN 46176

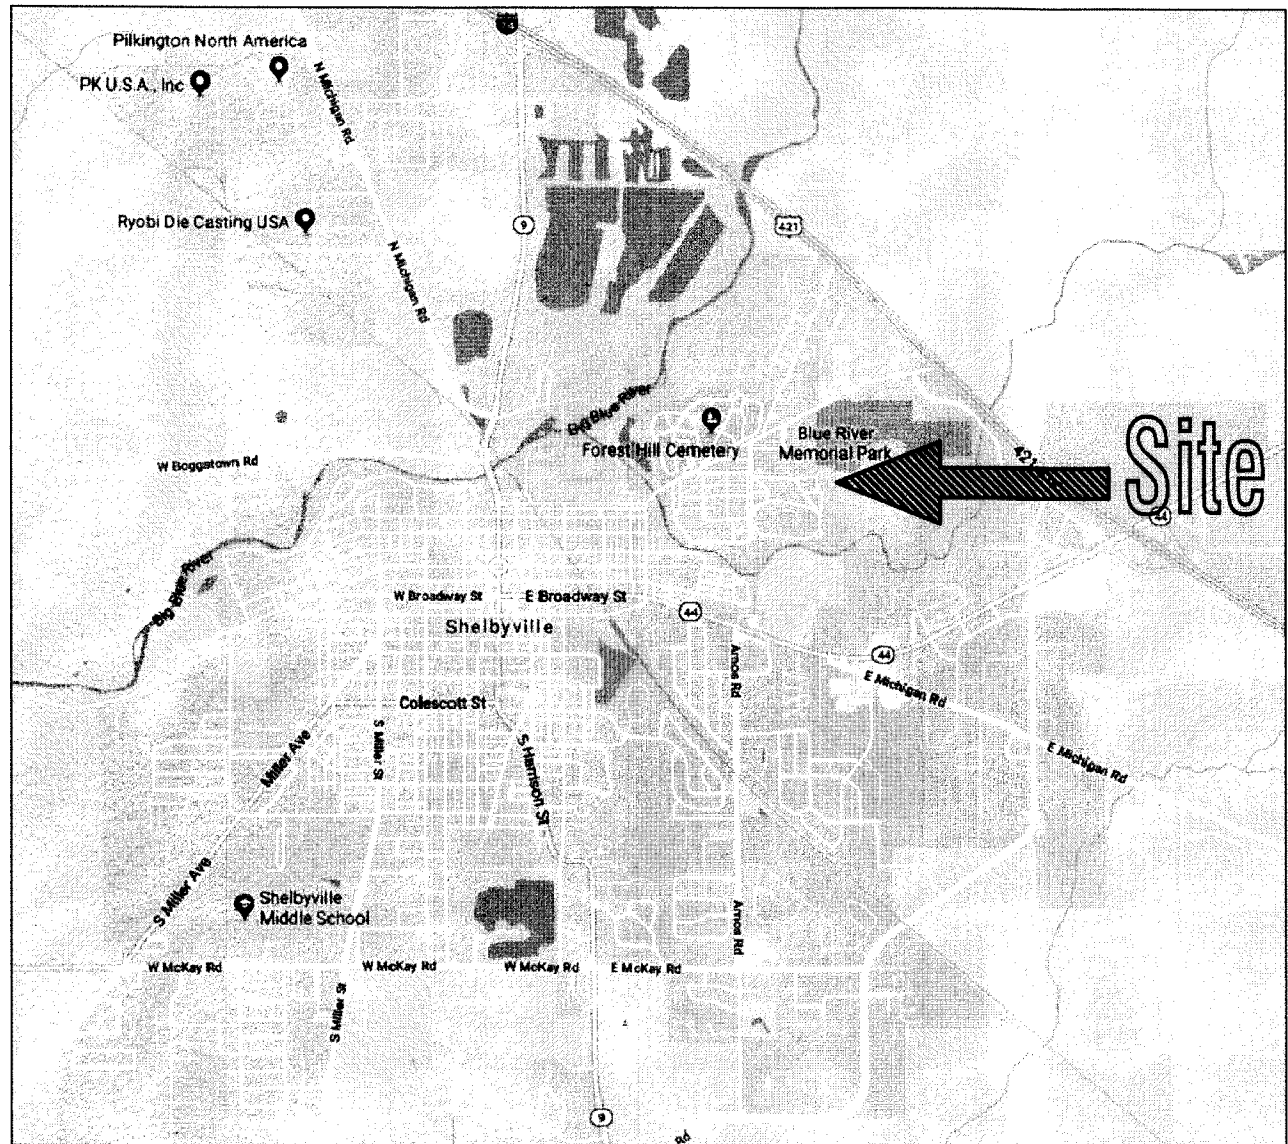


VICINITY MAP


OWNER:

SHELBYVILLE PARKS & REC. DEPT.  
945 S. TOMPKINS ST.  
SHELBYVILLE, IN 46176  
CONTACT: TERRY PIERCE  
PHONE: 317.392.5128

PREPARED BY:

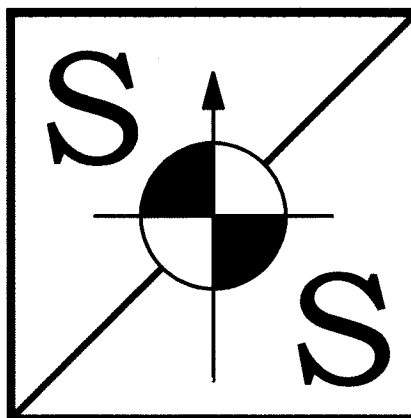

**SPACE and SITES, LLC**  
ENGINEERING, BUILDING DESIGN  
6 East Taylor St. Shelbyville, IN 46176  
PH 317.392.4444 FAX 317.392.0709  
www.spaceandsites.com  
e-mail: spaceandsites@sbcglobal.net

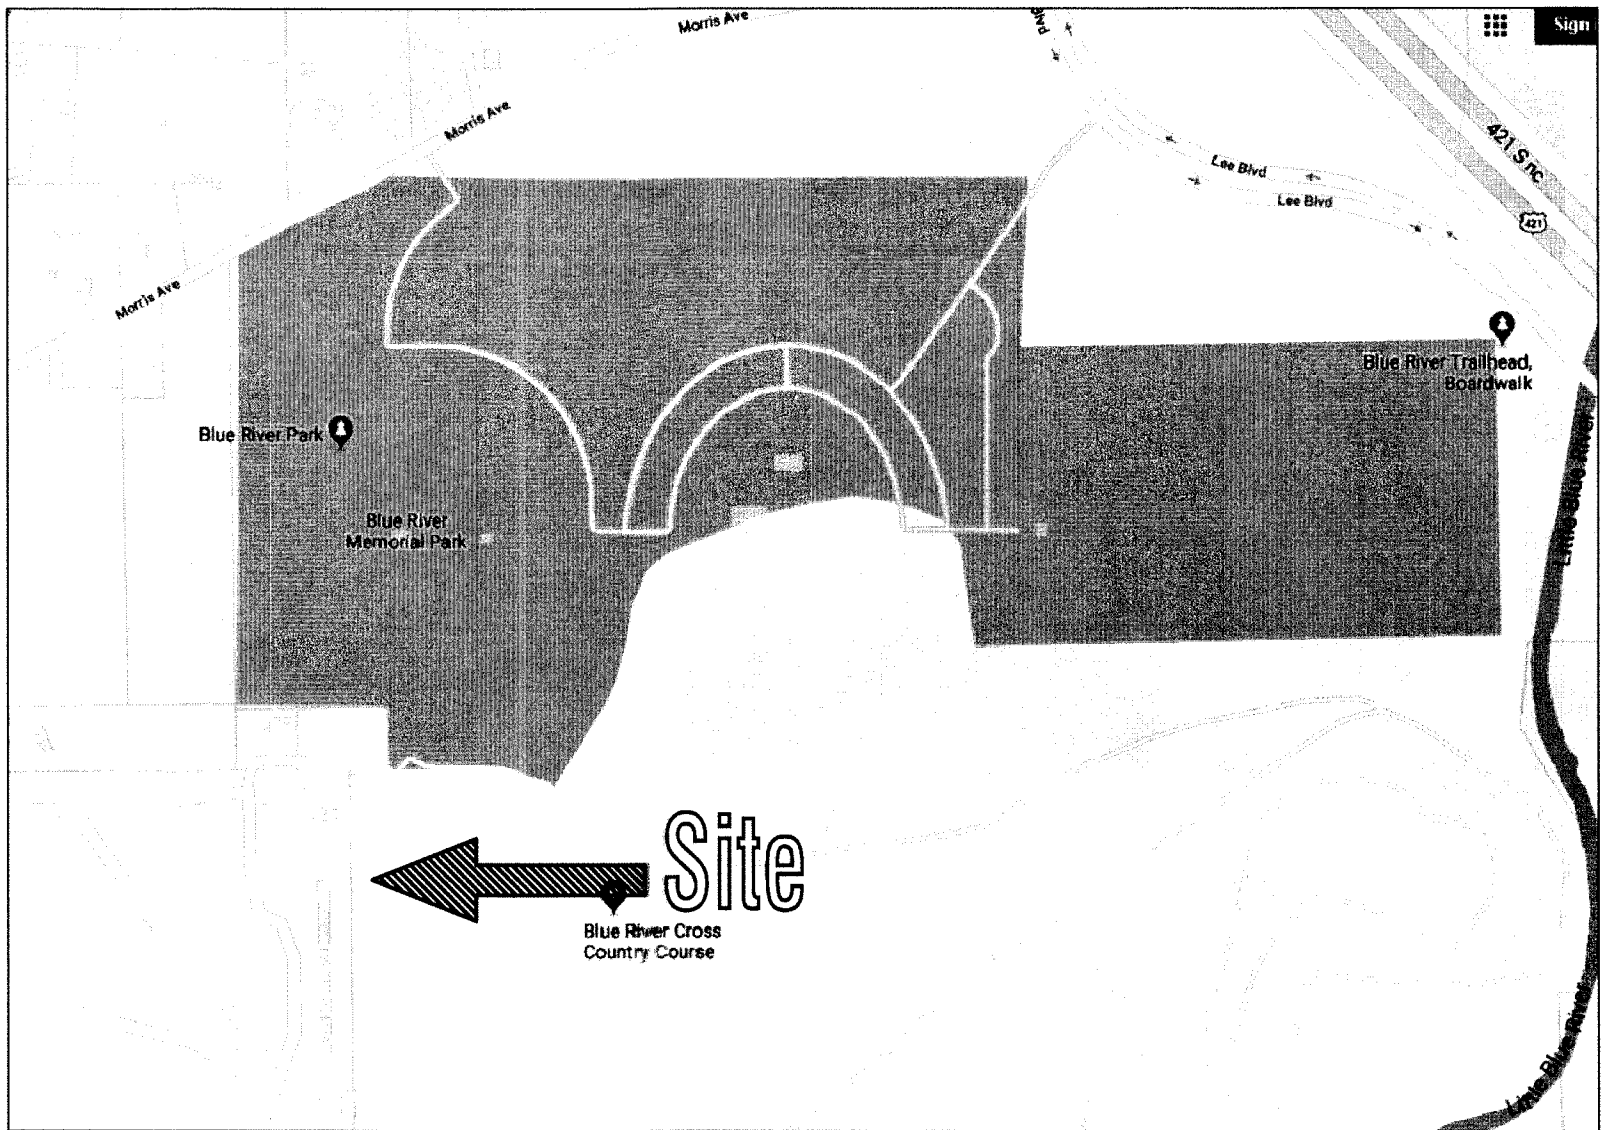

LOCATION MAP

FOR BID PURPOSES ONLY

INDEX OF DRAWINGS	
SHEET NO.	DESCRIPTION
	COVER
C100	PROPOSED SITE/UTILITY PLAN
C101	PROPOSED DRAINAGE PLAN
C102	PROPOSED EROSION CONTROL PLAN
C103	EROSION CONTROL DETAILS
C104	PROPOSED SITE LIGHTING PLAN
C105	(SWPPP) STORM WATER POLLUTION PREVENTION PLAN
G100	PROPOSED LIFE SAFETY PLAN
S100	PROPOSED FOUNDATION PLAN
S101	PROPOSED FOUNDATION DETAILS
A100	PROPOSED FLOOR PLAN
A200	PROPOSED EXTERIOR ELEVATIONS
M100	PROPOSED MECHANICAL PLAN
E100	PROPOSED ELECTRICAL PLAN
E101	PROPOSED LIGHTING PLAN
P100	PROPOSED PLUMBING PLAN
P101	PROPOSED PLUMBING DETAILS



REVISIONS		
SHEET NO.	DATE	DESCRIPTION
NOTED	4/17/19	O.H. DOOR, WALL TO CEILING
NOTED	6/10/19	EXTERIOR ELEV., ELECT. PANEL, PLUMBING, NOTES

GENERAL NOTES:

- 1.) CONTRACTOR SHALL BE RESPONSIBLE FOR OBTAINING OR VERIFYING THAT ALL PERMITS AND APPROVALS ARE OBTAINED FROM THE CITY, COUNTY, AND STATE AGENCIES PRIOR TO CONSTRUCTION.
- 2.) CONTRACTOR SHALL BE RESPONSIBLE TO DETERMINE THE EXACT LOCATION OF ALL EXISTING UTILITIES IN THE VICINITY OF THE CONSTRUCTION AREA PRIOR TO STARTING CONSTRUCTION. CONTRACTOR SHALL NOTIFY ENGINEER IMMEDIATELY IF ANY UTILITY CONFLICTS ARE DISCOVERED OR IF UTILITY LOCATIONS DIFFER SIGNIFICANTLY FROM LOCATIONS SHOWN ON THE PLANS.
- 3.) CONTRACTOR SHALL BE RESPONSIBLE FOR NOTIFICATION AND COORDINATION OF ALL CONSTRUCTION WITH CITY AND ALL RESPECTIVE UTILITY COMPANIES PRIOR TO CONSTRUCTION.





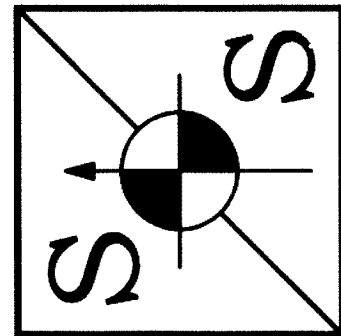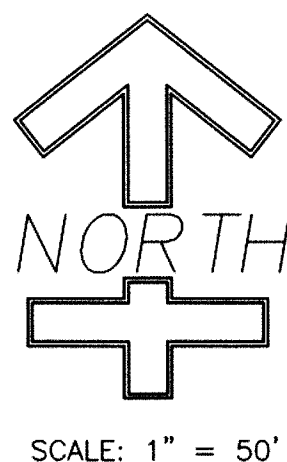

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e-mail: [spaceandsites@sbcglobal.net](mailto:spaceandsites@sbcglobal.net)

SYMBOL	CHECKED	REVISION	DATE
IN		REVISED SITE	6/10/19
CERT.			
-			
SCALE			
1"=50'			
DRAWN			
RC			

FOR BID PURPOSES ONLY

SHEET NAME
PROPOSED SITE/UTILITY PLAN

PROJECT NAME
SHELBYVILLE PARKS & REC. DEPT. MAINTENANCE BUILDING, BLUE RIVER PARK 1021 MORRIS AVE., SHELBYVILLE, IN 46176

DATE: MAY 13, 2019

**PROJECT NO.: 18015**

SHEET NO.

C100




NOTES:

- ① DOWNSPOUT DRAIN (2)–6" DRAIN TIED TO 12" HDPE.
- ② REAR ASPHALT AREA. INSTALL 6' HIGH SPLIT FACE BLOCK FENCE w/ (2) 8' WIDE x 6' TALL GATES AT DRIVE ENTRANCE. GATES–USE 1x6 WOOD BOARDS ON STEEL FRAME. SEE DETAIL.
- ③ VERIFY KNOX BOX LOCATION AND INSTALLATION PER CITY STANDARDS.



LEGEND

VERIFY ALL UTILITIES PRIOR TO CONSTRUCTION

- 000.00 = EXISTING GRADE  
000.00 = PROPOSED GRADE  
 → = PROPOSED FLOW  
 --- 000 --- 000 --- = PROPOSED SWALE  
 -X-X-X-X-X-X-X- = PROPOSED FENCE (SEE DETAIL C100)  
 --- PUGE --- PUGE --- = PROPOSED 400 AMP, 1Ø PANEL WITH 4 LUGS.

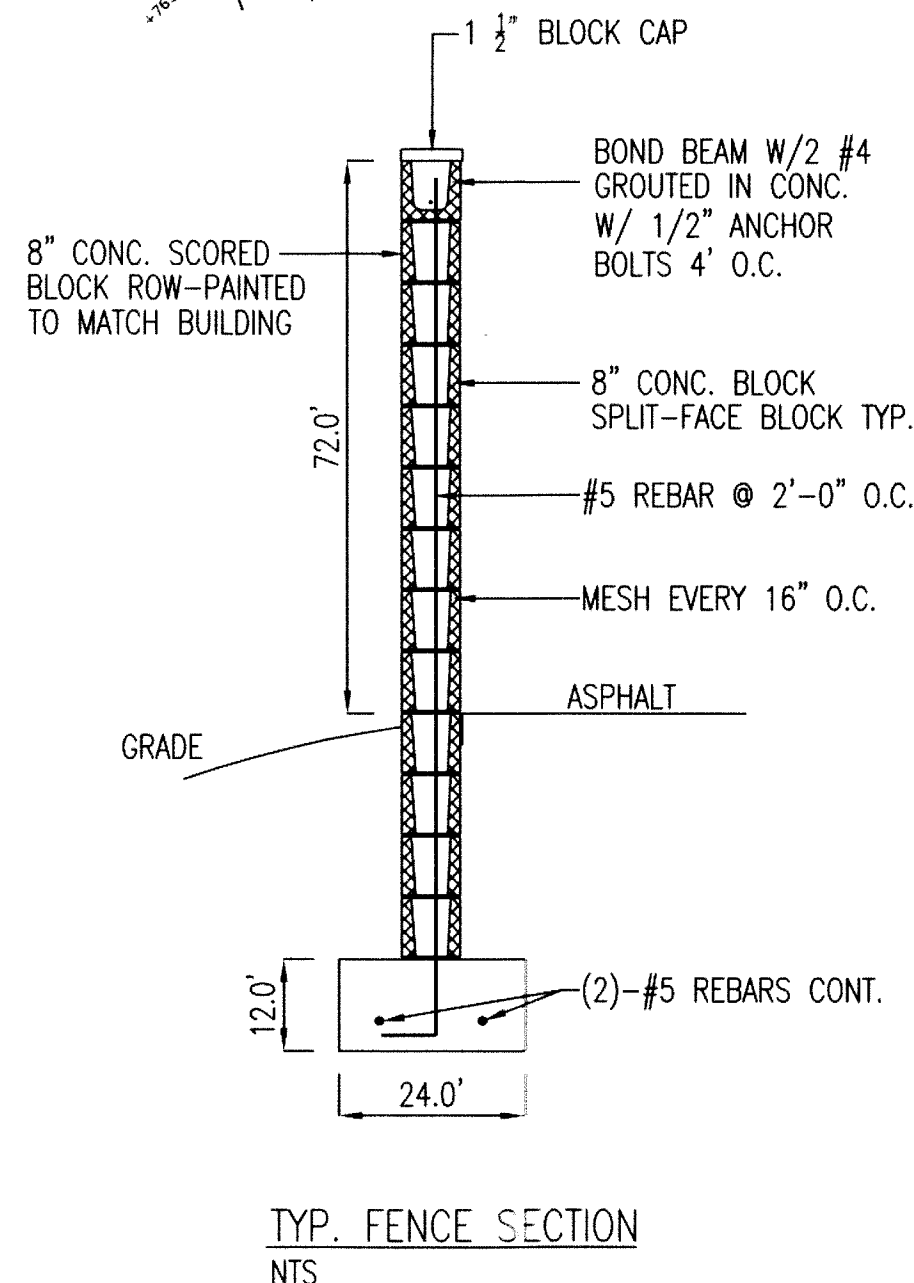



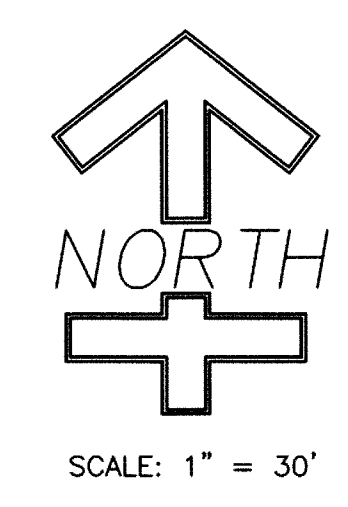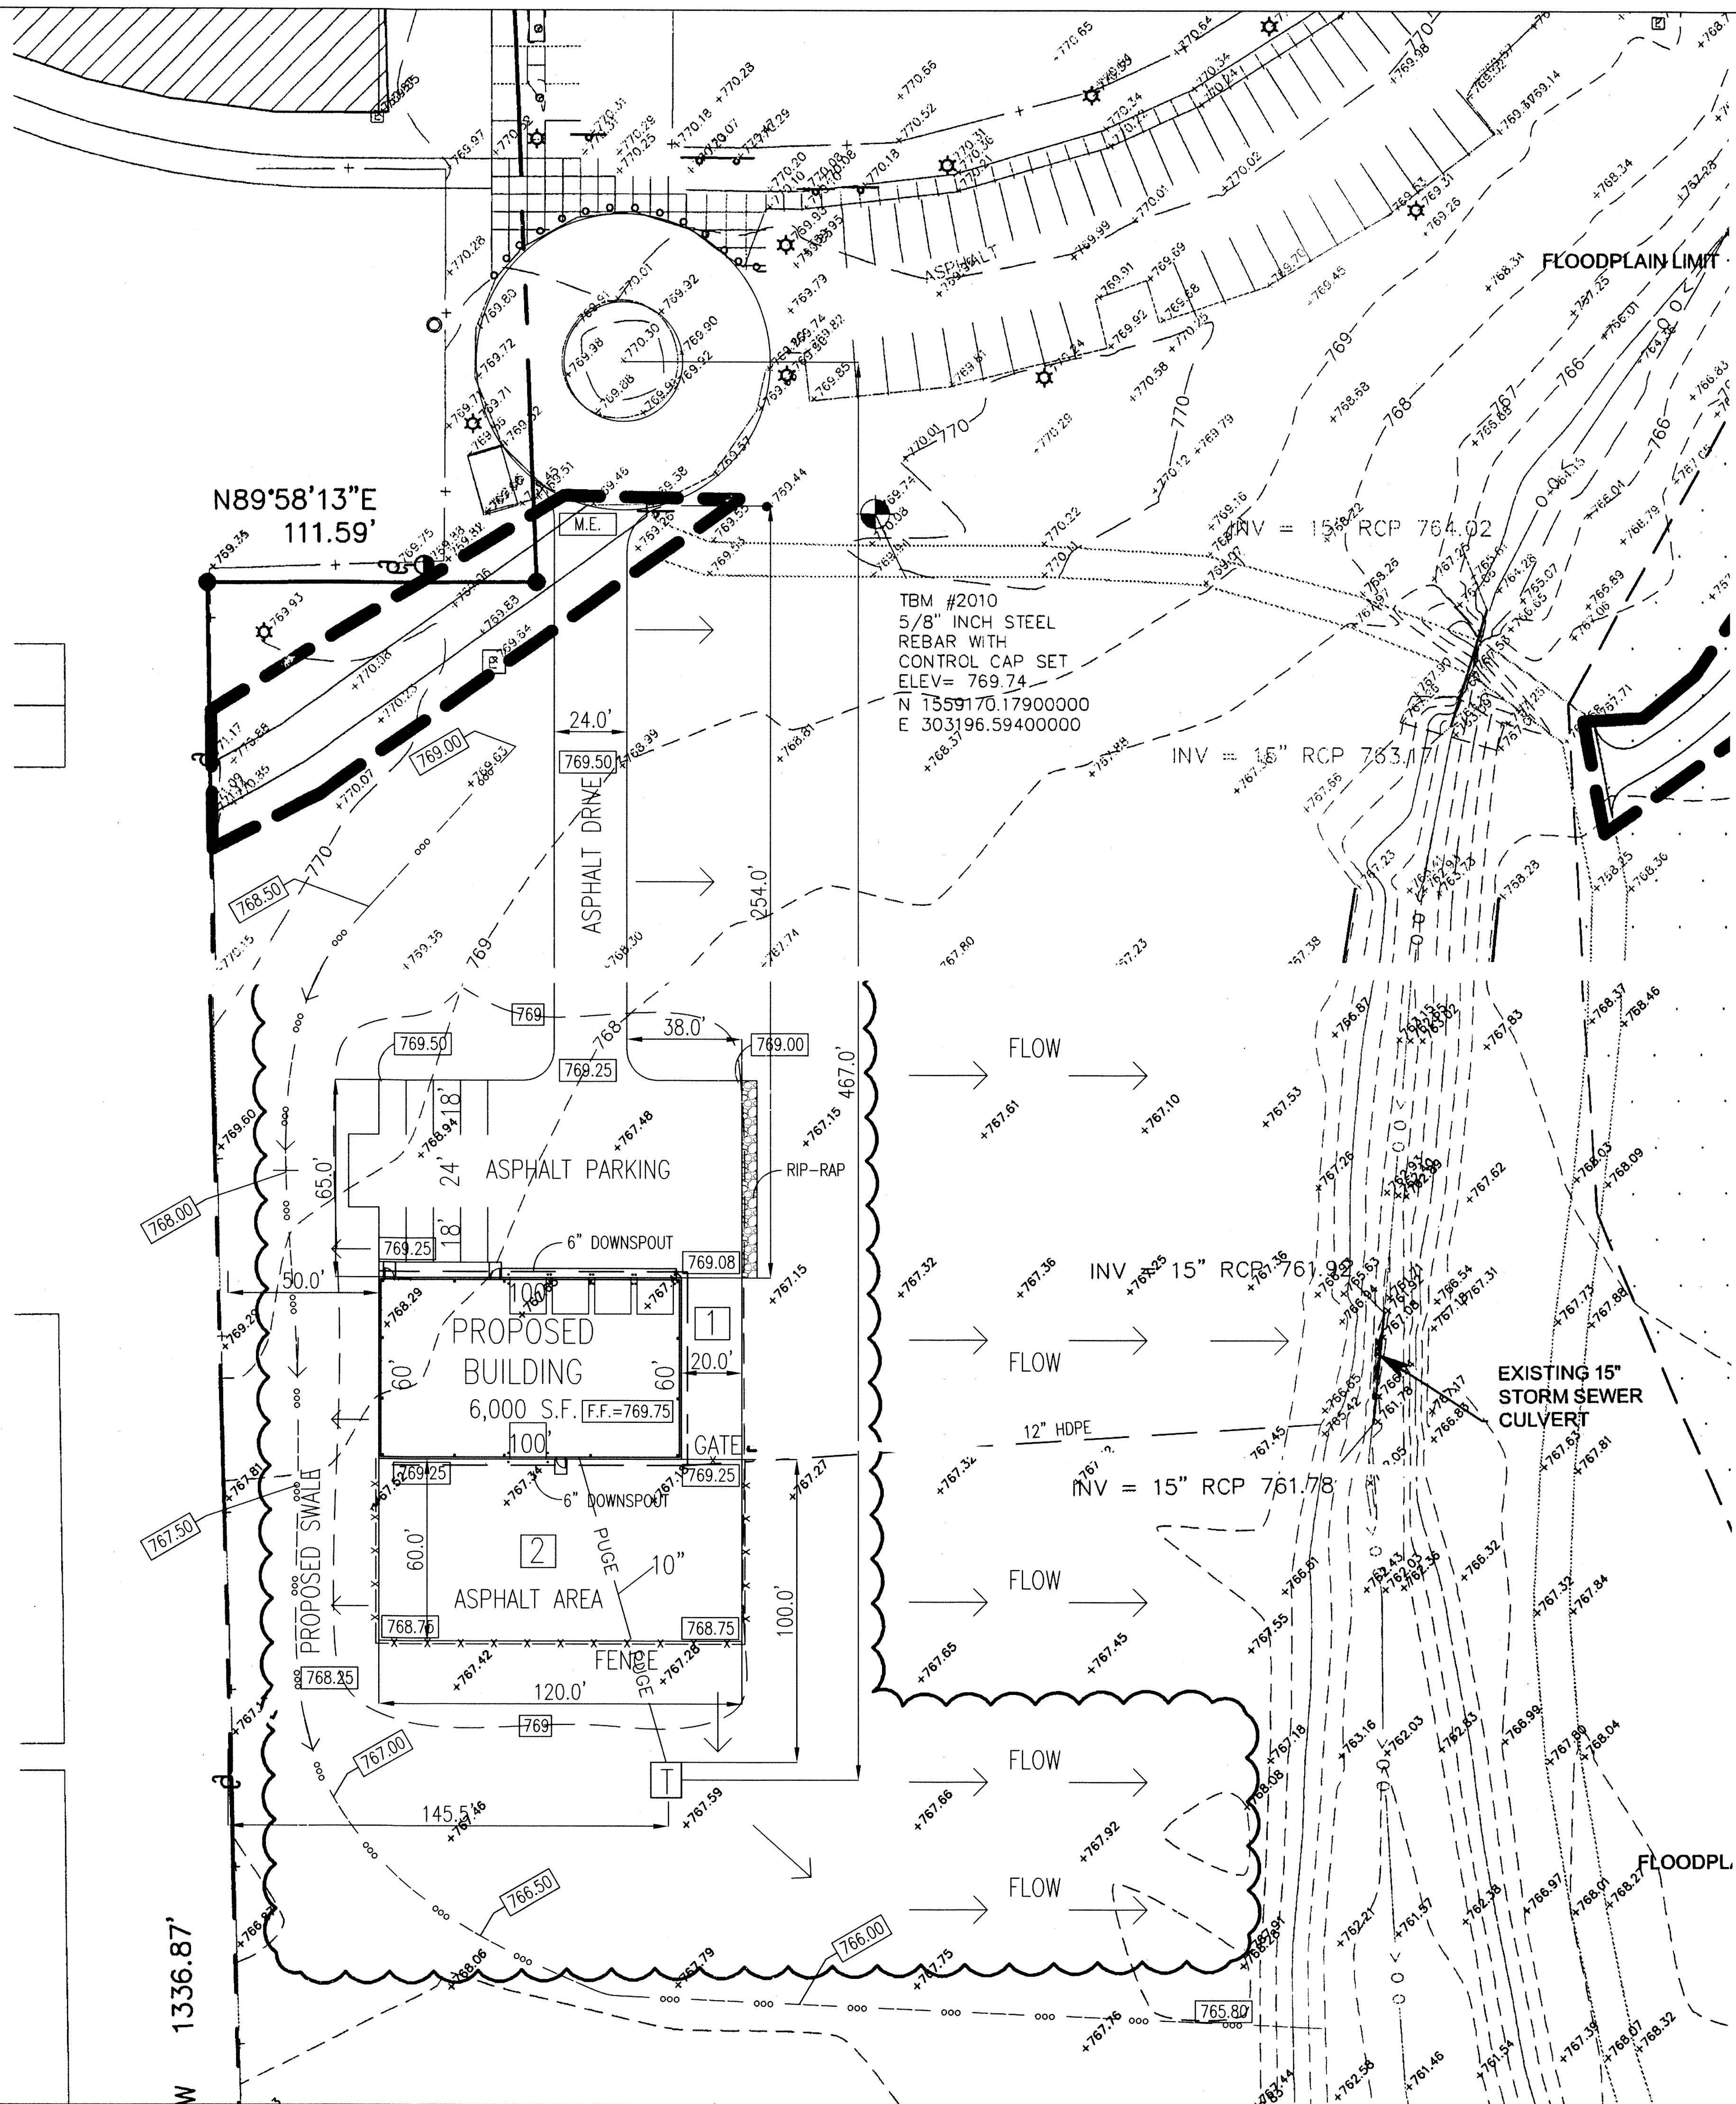

PER CITY SPECS.

ASPHALT OVER STONE

d=17 1/2"

1 1/2" HMA SURFACE TYPE C (165 #/SY)  
3" HMA INTERMEDIATE TYPE C (330 #/SY) OVER  
5" HMA BASE TYPE C (550 #/SY)

8" COMPACTED INDOT NO. 53 CRUSHED AGGREGATE BASE (2 LIFTS)

- NOTES:
- 1 DOWNSPOUT DRAIN (2)-6" DRAIN TIED TO 12" HDPE.
  - 2 REAR ASPHALT AREA. INSTALL 6' HIGH SPLIT FACE BLOCK FENCE w/ (2) 8' WIDE x 6' TALL GATES AT DRIVE ENTRANCE. GATES-USE 1x6 WOOD BOARDS ON STEEL FRAME. SEE DETAIL.

- LEGEND
- VERIFY ALL UTILITIES PRIOR TO CONSTRUCTION
- 000.00 = EXISTING GRADE
  - 000.00 = PROPOSED GRADE
  - = PROPOSED FLOW
  - ooo — = PROPOSED SWALE
  - x-x-x-x- = PROPOSED FENCE (SEE DETAIL C100)
  - PUGE — = PROPOSED 400 AMP, 1Ø PANEL WITH 4 LUGS.

FOR BID PURPOSES ONLY



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CHECKED	SYMBOL	REVISION	DATE
IN	REVISED SITE		6/10/19
CERT.			
SCALE			
DRAWN			
RC			

SHEET NAME

PROPOSED DRAINAGE PLAN

PROJECT NAME


SHELBYVILLE PARKS & REC. DEPT.  
MAINTENANCE BUILDING, BLUE RIVER PARK  
1021 MORRIS AVE., SHELBYVILLE, IN 46176

DATE: MAY 13, 2019


PROJECT NO.: 18015

SHEET NO.

C101

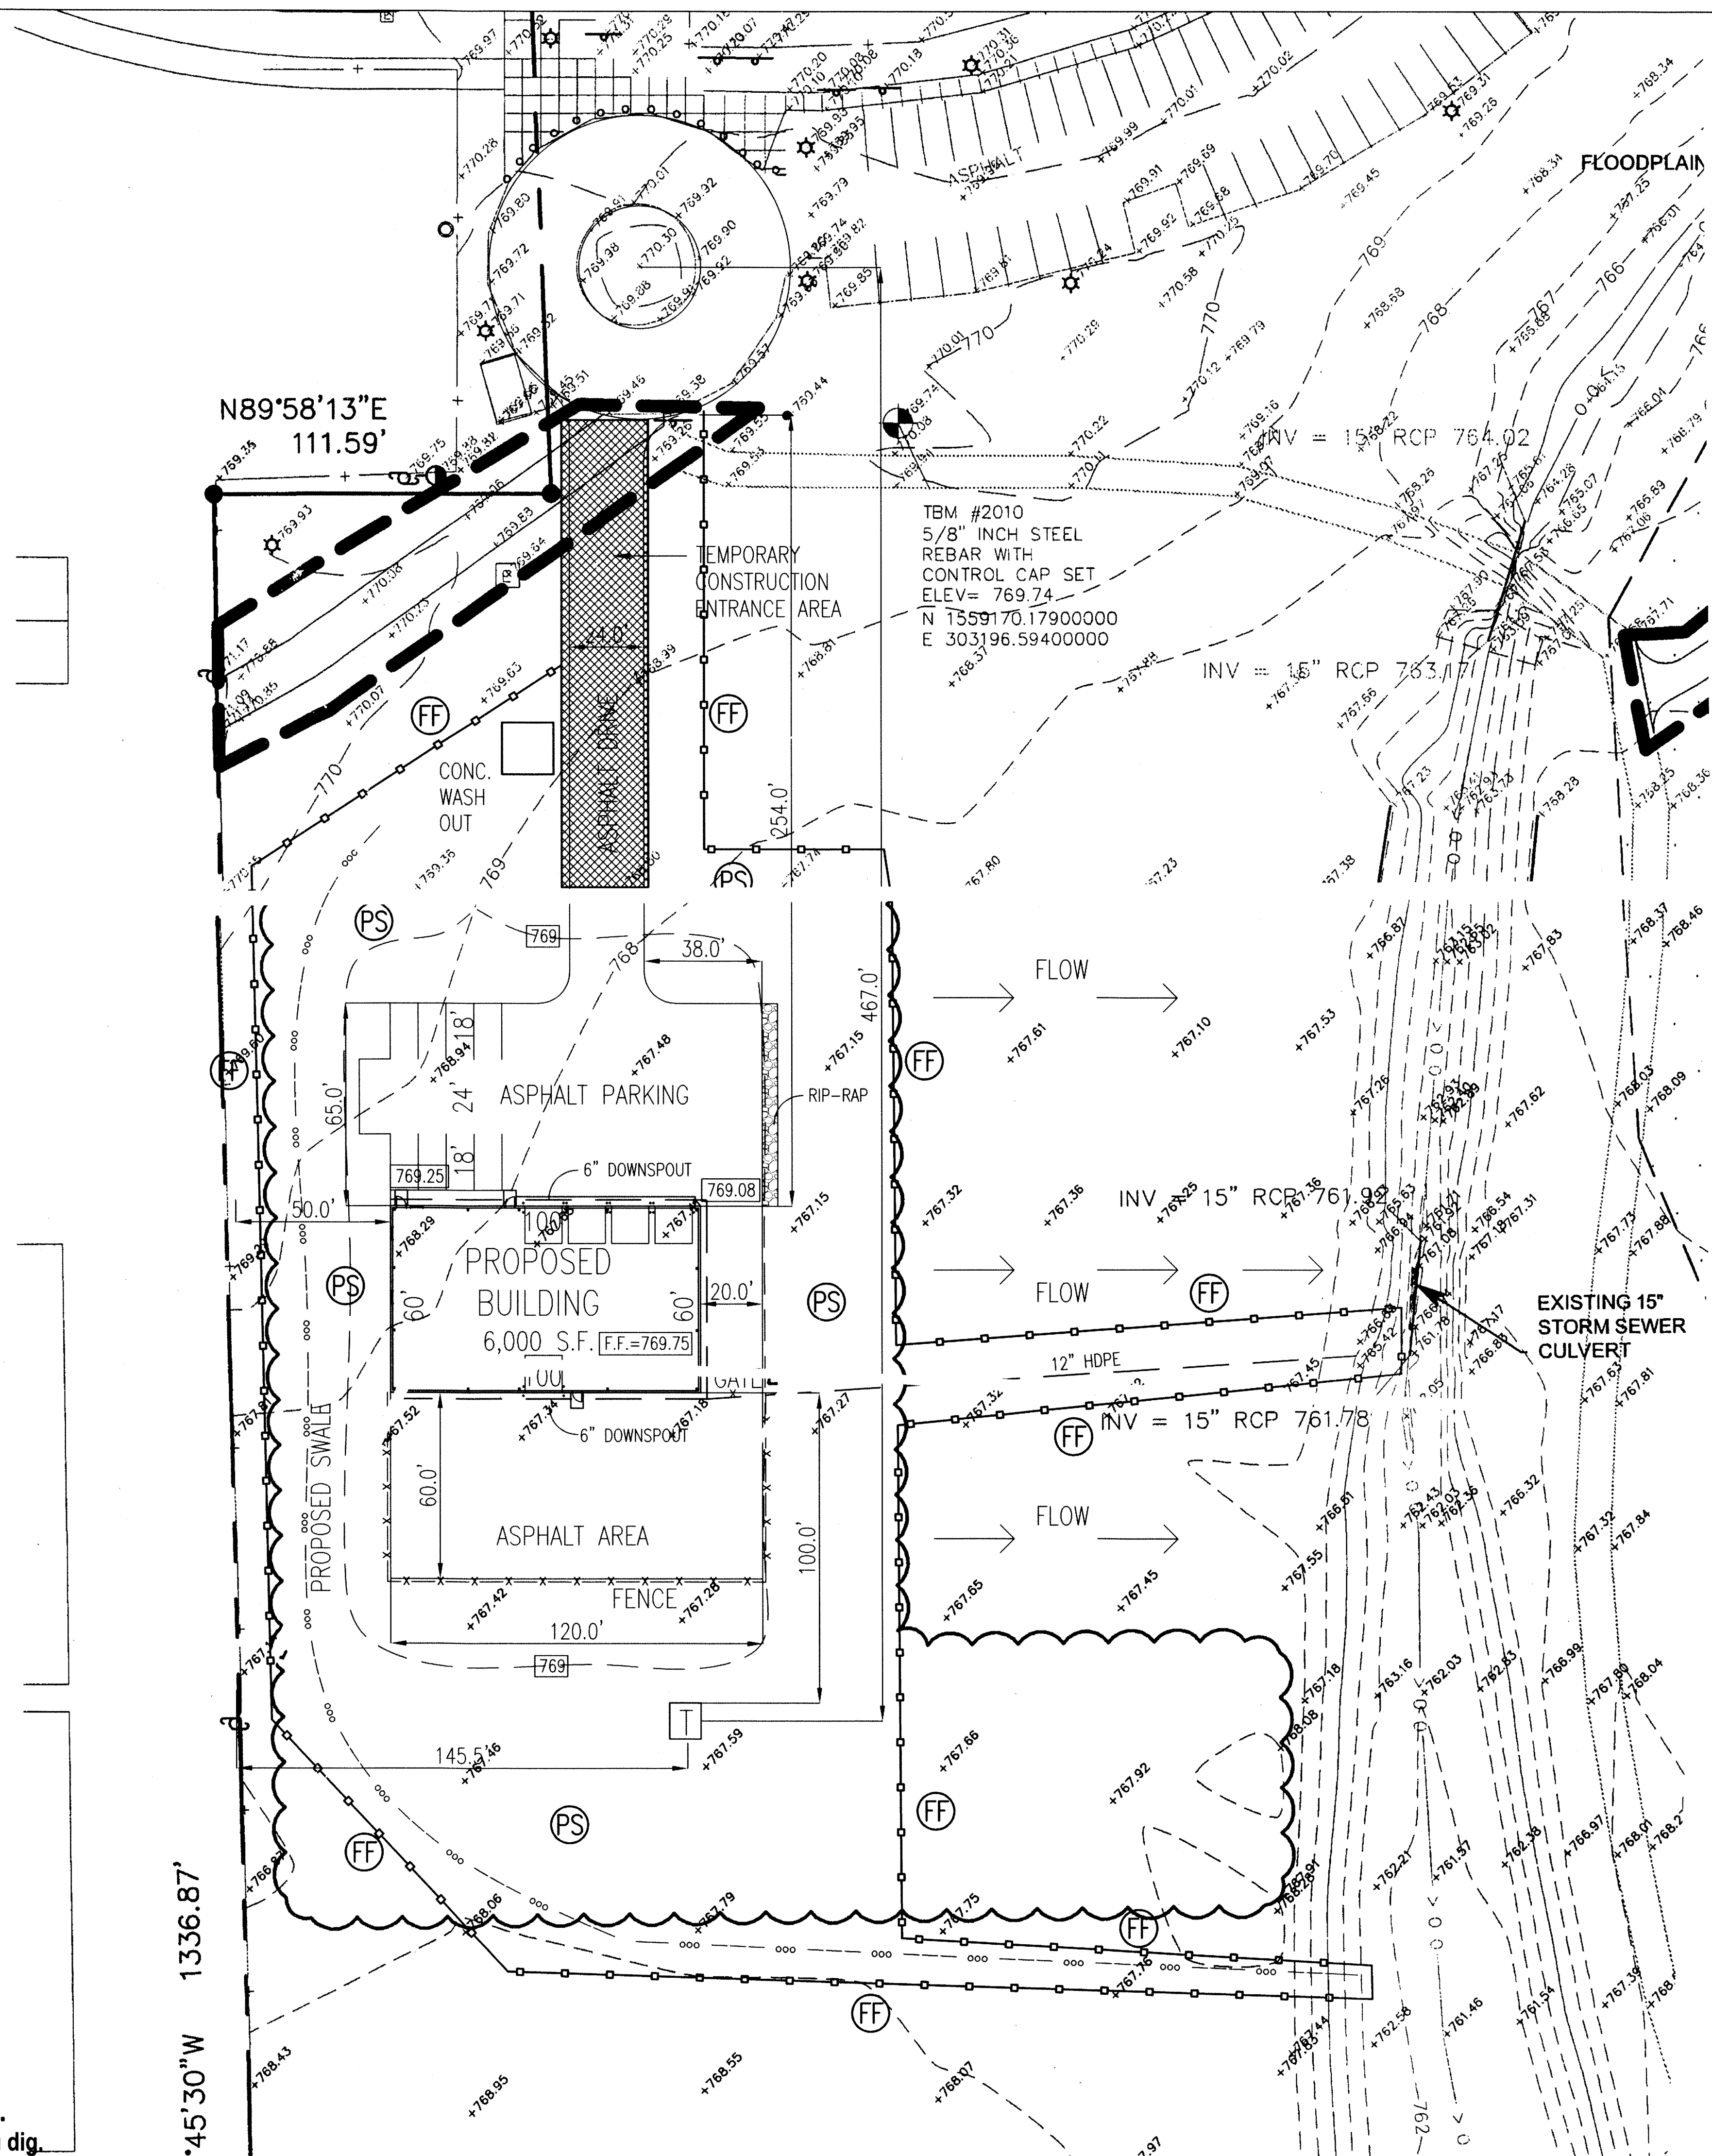

- EROSION CONTROL LEGEND:
- = FILTER FENCE
  - = EROSION CONTROL BLANKETS
  - = DENOTES AREA TO BE PERMANENTLY SEEDED
  - = INDICATES CONSTRUCTION ENTRANCE AREA
  - = INDICATES INLET PROTECT FILTER MESH
  - = INDICATES CONCRETE WASH OUT BASIN

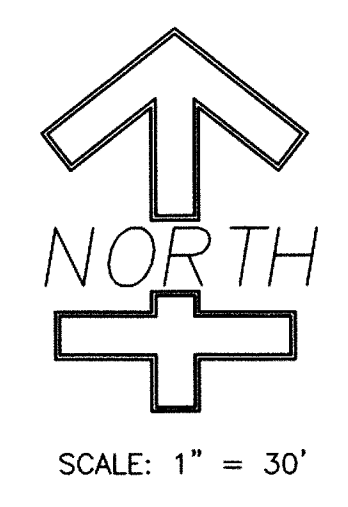

FOR BID PURPOSES ONLY




SHEET NAME PROPOSED EROSION CONTROL PLAN		CHECKED TN CERT.	SYMBOL	REVISION	DATE
PROJECT NAME SHELBYVILLE PARKS & REC. DEPT. MAINTENANCE BUILDING, BLUE RIVER PARK 1021 MORRIS AVE., SHELBYVILLE, IN 46176					6/10/19
DATE: MAY 13, 2019					
PROJECT NO.: 18015					
SHEET NO.					
C102					

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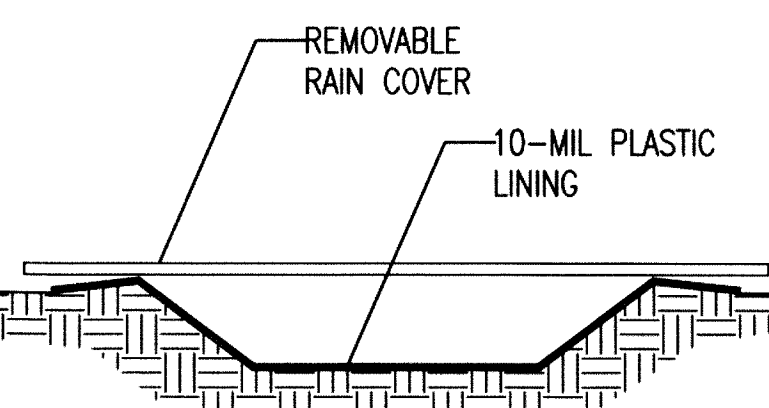
The diagram illustrates a raised garden bed layout. The bed is rectangular, with a central area labeled 'VEGETABLES'. The bed is bordered by a '10-MIL PLASTIC LINING' and a 'STRAW BALE (OR WOOD FRAME EQUIV.)'. The bed is divided into sections by 'STAKES (2 PER BALE)'. The dimensions are given as 10' x 10'.

ABOVE-GROUND BASIN  
PLAN VIEW


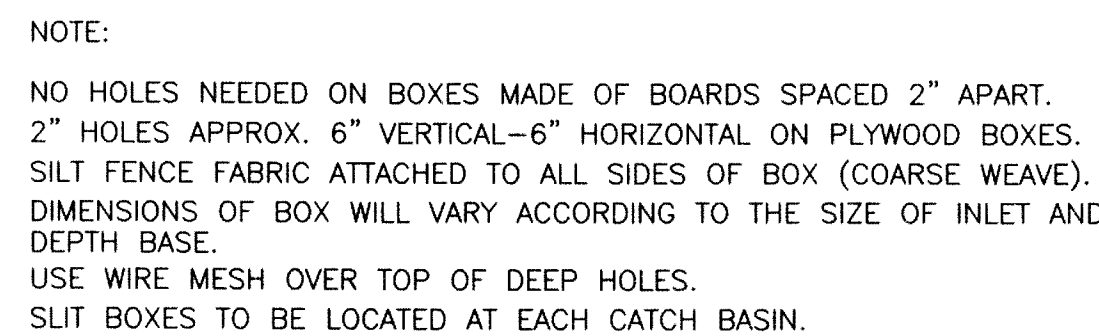


The diagram shows a large square with a smaller square inscribed within it. The vertices of the inner square are located at the midpoints of the sides of the outer square. This configuration demonstrates that the area of the outer square is four times the area of the inner square.

BELOW-GROUND BASIN  
PLAN VIEW



BELOW-GROUND BASIN  
SECTION

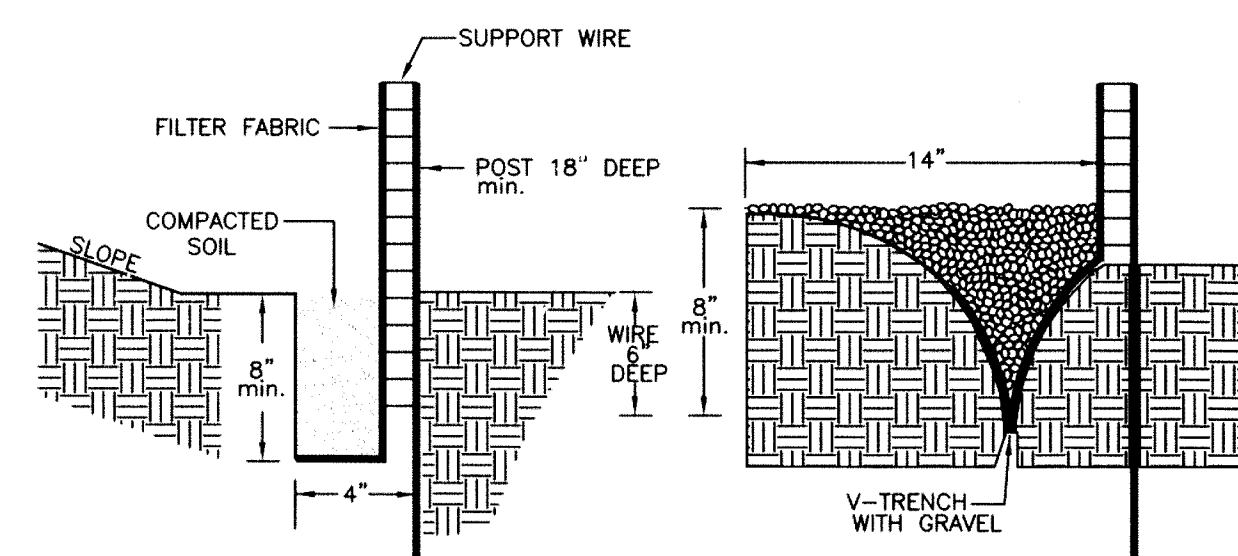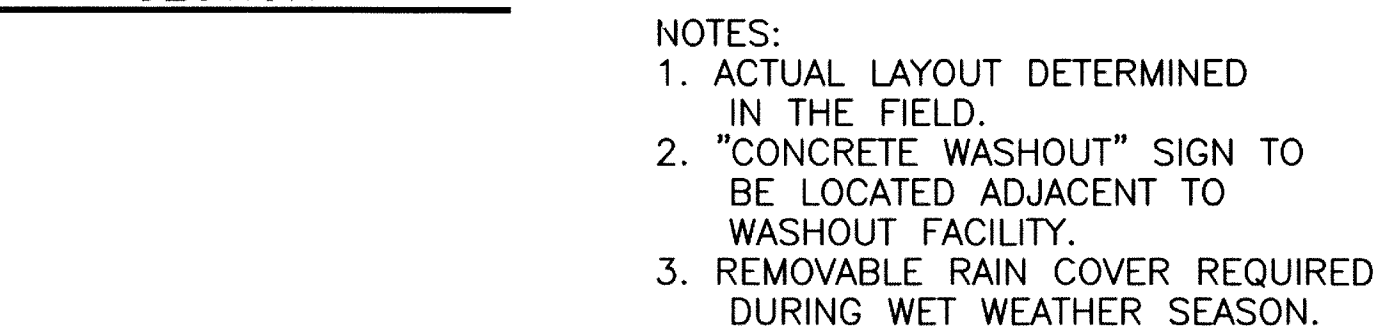


FILTER FENCE SHALL BE NUTEC 3NWS-6 OR EQUAL.

FINISH GRADING AND SEEDING


1. OVER THE APPROVED ROUGH GRADE (SEE SECTION E), SPREAD 4" MINIMUM OF TOPSOIL OR APPROVED FILL TO SUCH DEPTH AS WILL FINISH TO THE REQUIRED FINISH GRADES AND CONTOURS AFTER ROLLING AND NATURAL SETTLEMENT. NEW GRADES SHALL SLOPE UNIFORMLY BETWEEN LEVELS ESTABLISHED ON THE PLANS AND INTERSECTIONS OF NEW GRADES WITH EXISTING GRADES SHALL BE UNIFORM AND SMOOTH.
2. FERTILIZER AND AGRICULTURAL LIMESTONE SHALL BE SPREAD UNIFORMLY OVER THE AREA TO BE SEEDDED. THEY SHALL BE MIXED INTO THE TOP 2" OF SOIL WITH A DISK HARROW, ROTARY TILLER OR OTHER APPROVED EQUIPMENT. FERTILIZER SHALL BE SPREAD AT THE RATE OF 800 POUNDS PER ACRE AND AGRICULTURAL LIMESTONE AT THE RATE OF 1/2 TON PER ACRE UNLESS OTHERWISE SPECIFIED.
3. TEMPORARY SEEDING IN THE AREAS WHERE STRIPPING, CUTS OR FILLS HAVE BEEN GRADED SHALL BE SEEDDED FOR SILT AND EROSION PROTECTION WITH ONE OF THE FOLLOWING METHODS:

A.EARLY SPRING MIX:	100% OATS
SEEDING RATE:	50 LBS./ACRE
B.SPRING OR LATE FALL MIX:	100% ANNUAL RYE
SEEDING RATE:	50 LBS./ACRE
C.FALL MIX:	100%PERENNIAL RYE
SEEDING RATE	50 LBS./ACRE

STRAW OR MULCH AS APPROVED BY THE ENGINEER SHALL BE  
APPLIED AT A RATE OF 2 TONS PER ACRE.

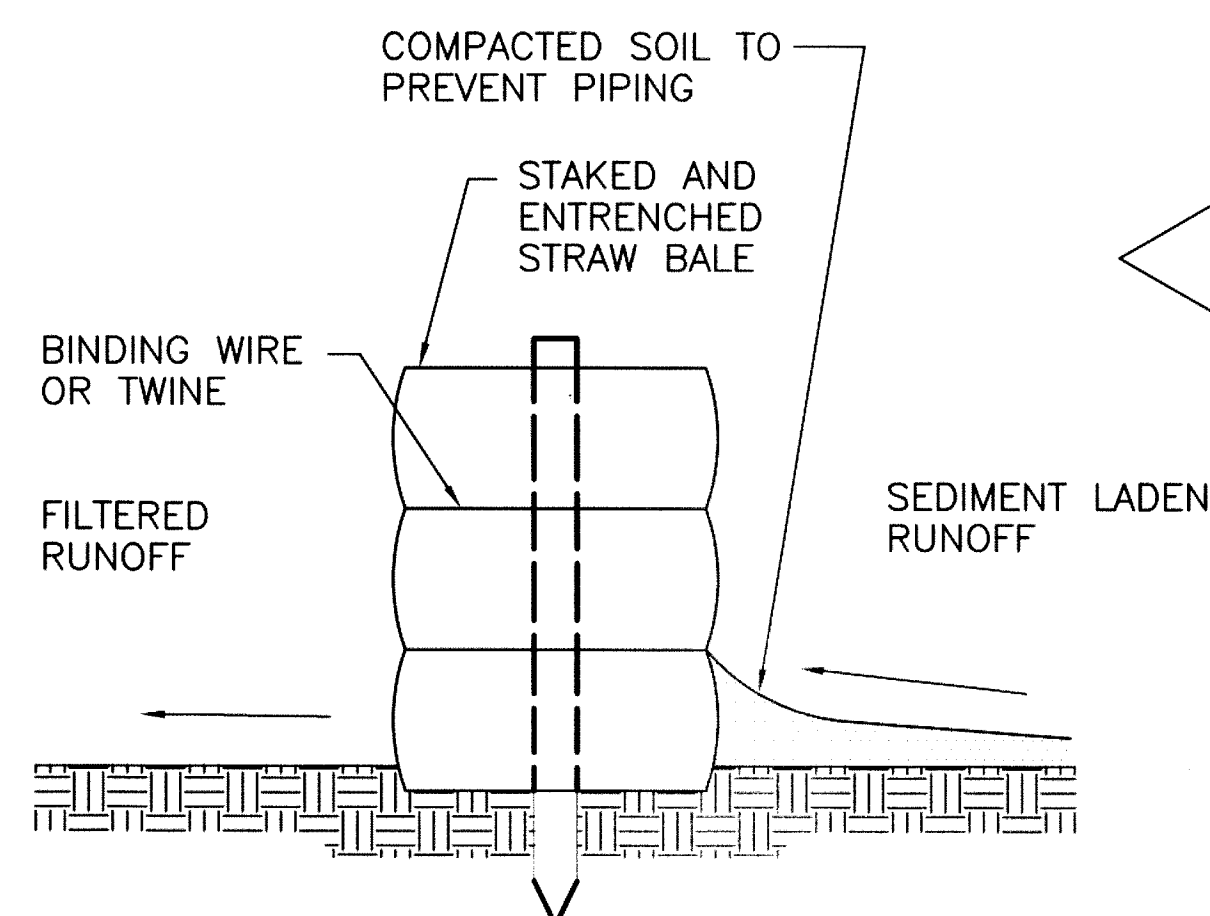

**STRAW BALE BARRIER DETAIL**  
PIPE INLET PROTECTION  
NTS

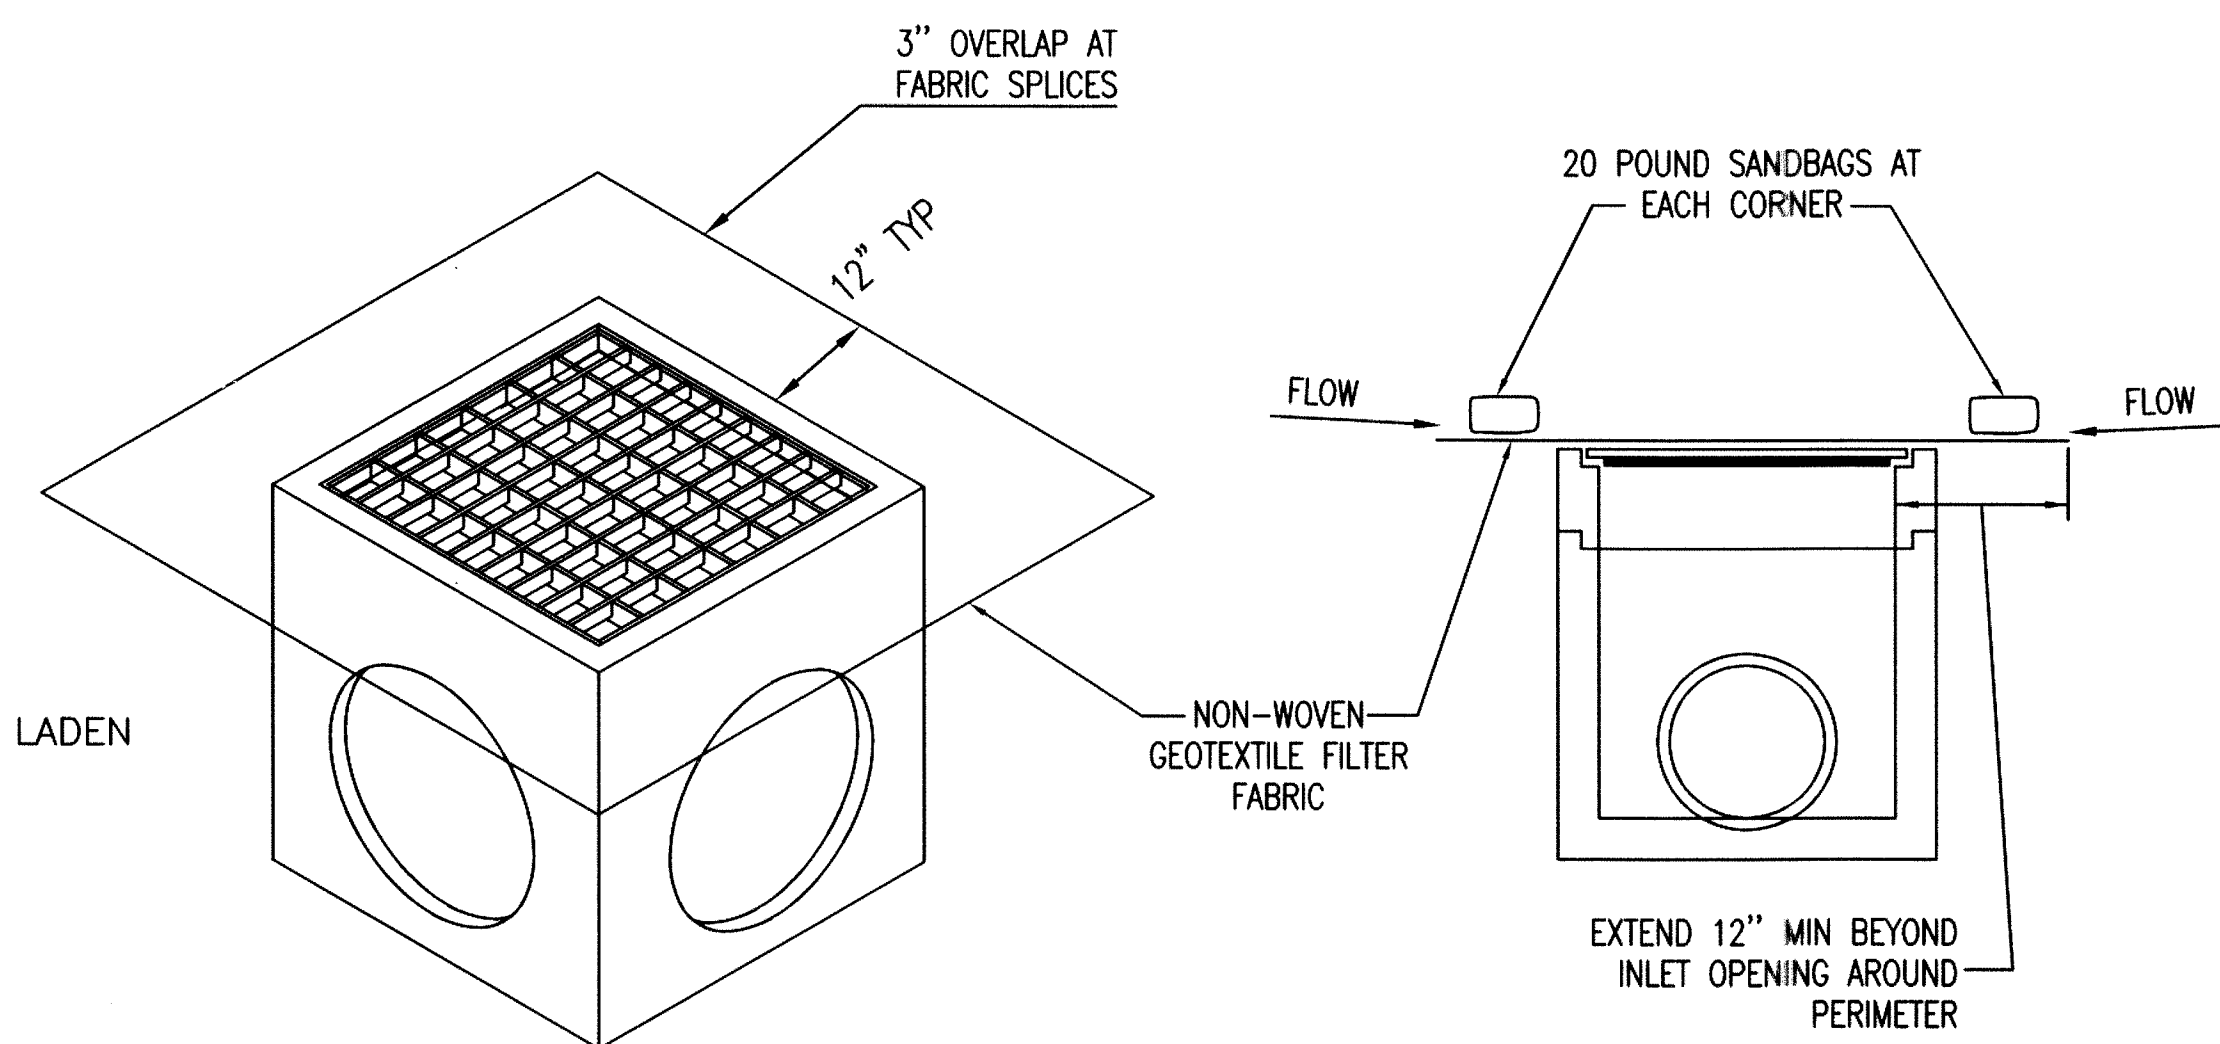


ISOMETRIC

CROSS SECTION


NOTES:

1. DAILY INSPECTION SHALL BE MADE BY THE CONTRACTOR AND SILT ACCUMULATION MUST BE REMOVED WHEN DEPTH REACHES 2".
2. CONTRACTOR SHALL MONITOR THE PERFORMANCE OF INLET PROTECTION DURING EACH RAINFALL EVENT AND IMMEDIATELY CLEAN THE INLET PROTECTION IF EXCESSIVE PONDING OCCURS.
3. INLET PROTECTIONS SHALL BE REMOVED AS SOON AS THE SOURCE OF SEDIMENT IS STABILIZED.

FILTER MESH INLET PROTECTION  
NTS

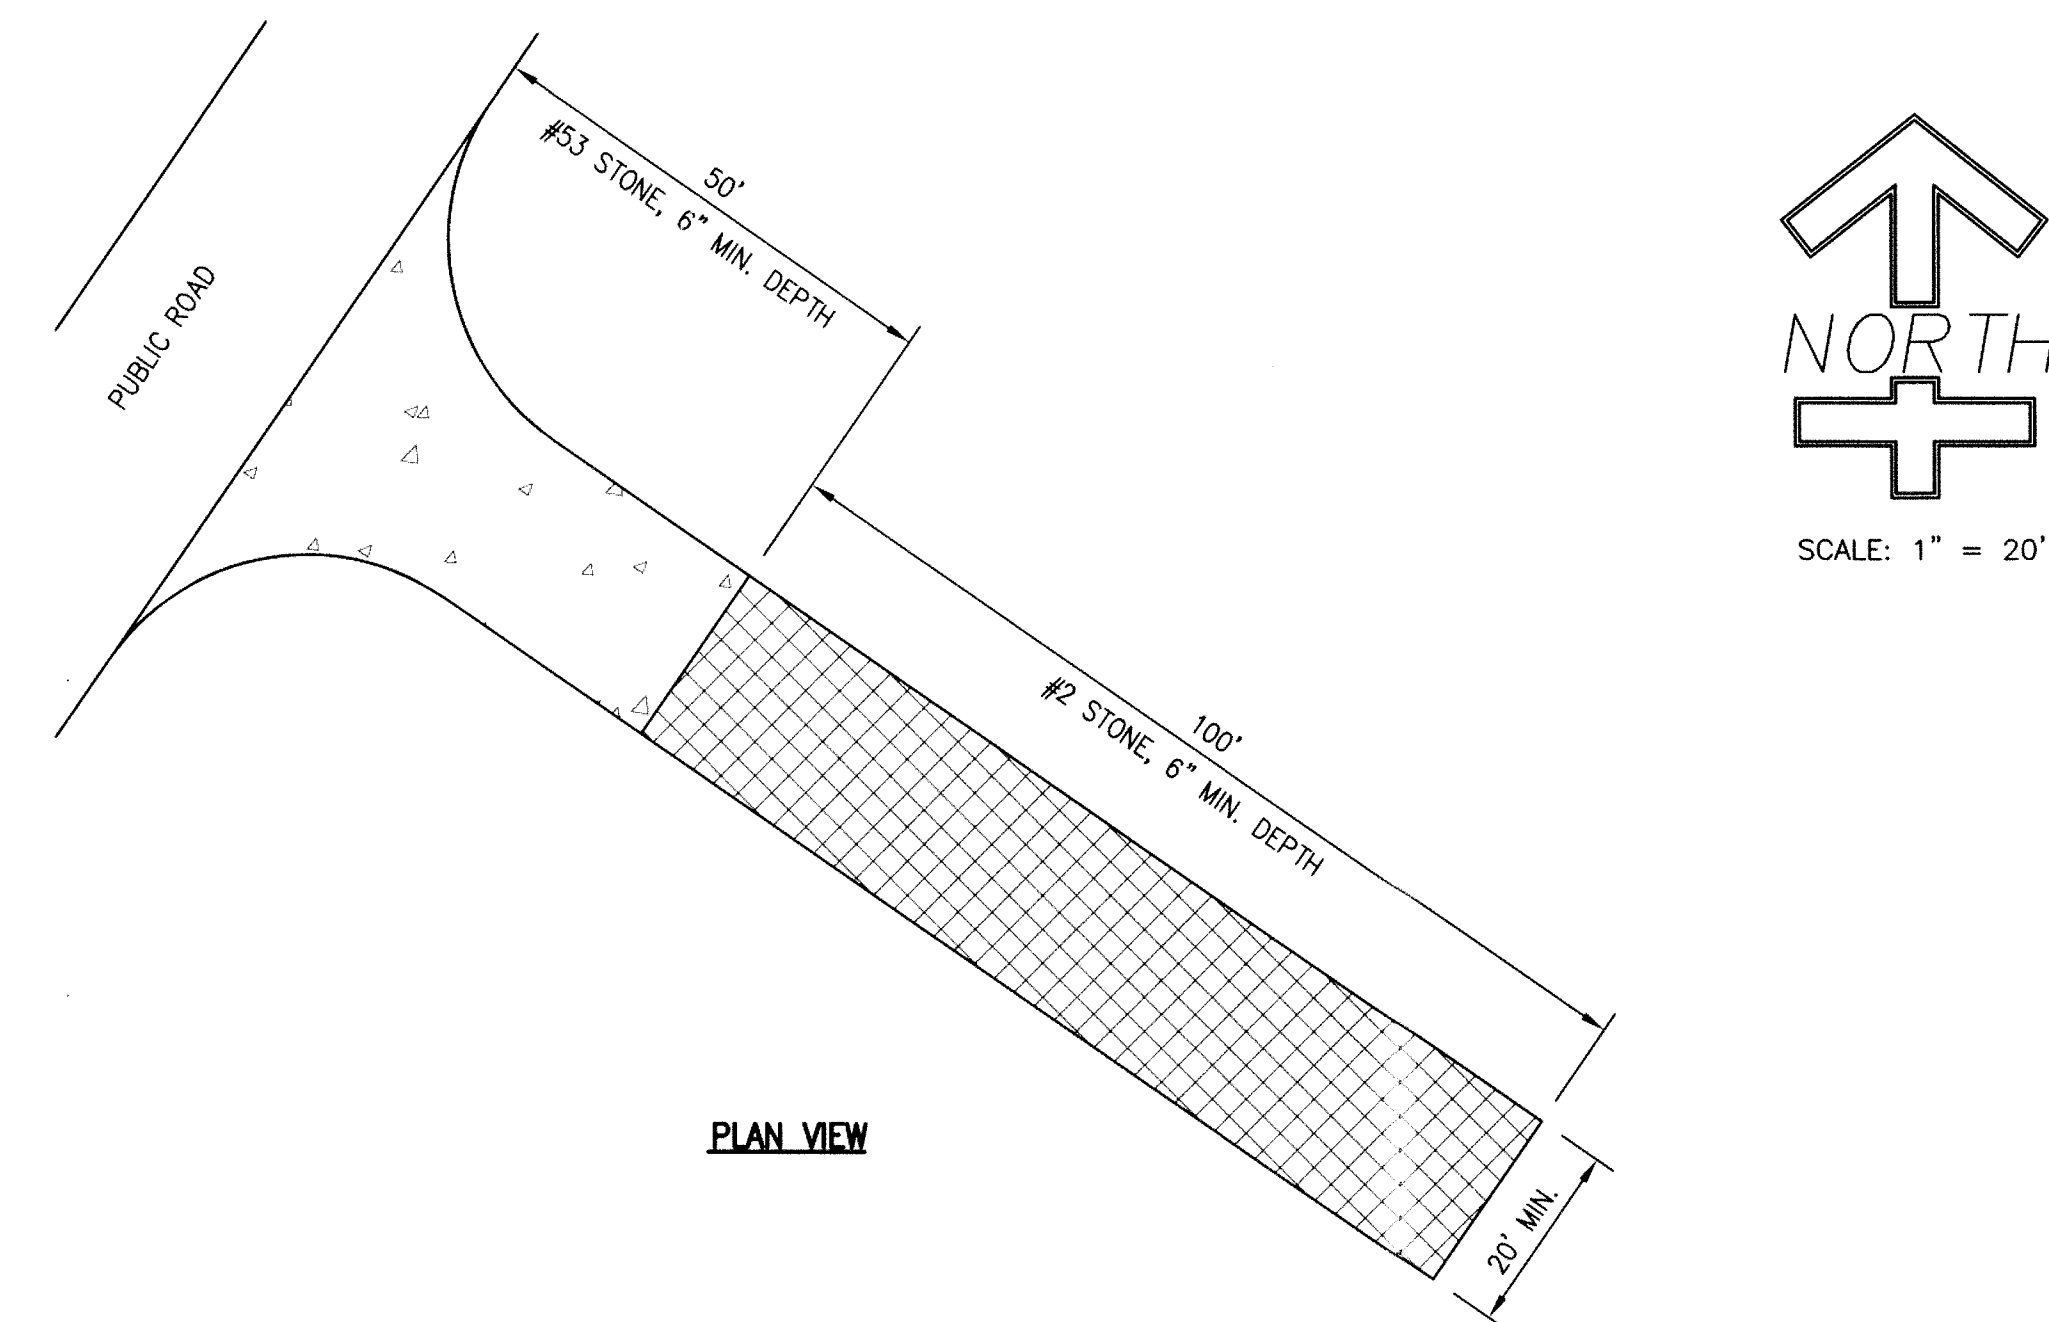

PLAN VIEW

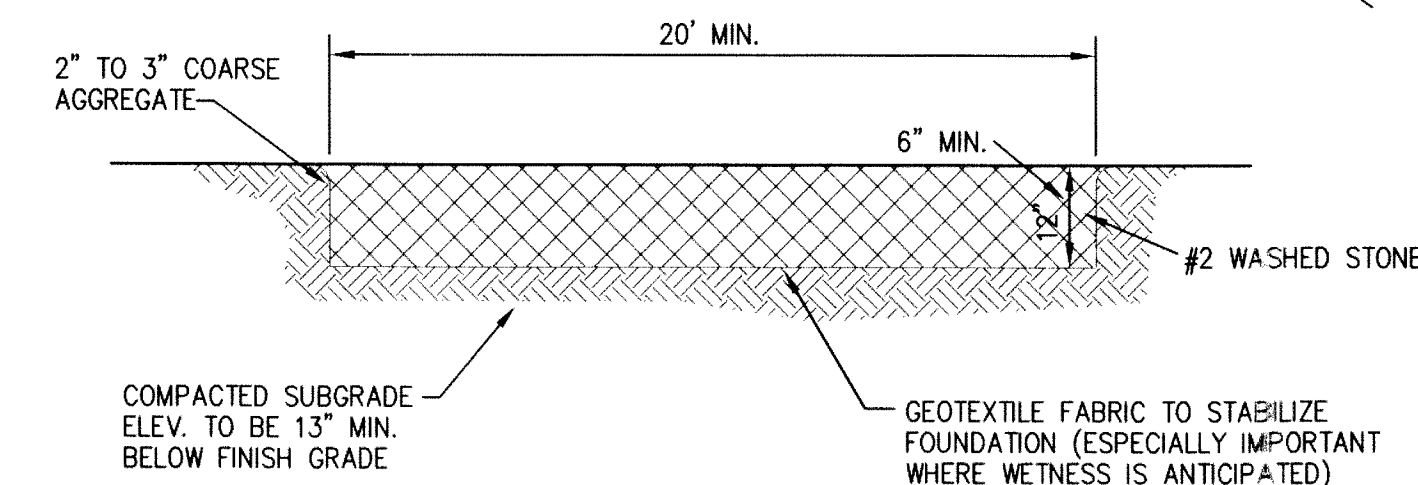


### PROFILE VIEW

NOTE:

1. STONE SIZE SHALL CONFORM TO ASTM D48 SIZE #1 (2" TO 3" DIA)
2. PERIODIC STONE TO DRESSING AND WASHING AS REQUIRED.

### TEMPORARY CONSTRUCTION ENTRANCE DETAIL

**SPACE and SITES, LLC**  
BUILDING DESIGN, PLANNING  
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www.spaceandsites.com  
e-mail: spaceandsites@sbcglobal.net

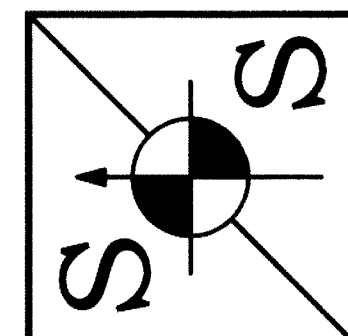[illegible]

CHECKED	TN	CERT.	-	SCALE	1"=20'	DRAWN	DC
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FOR BID PURPOSES ONLY

<p align="center"><b>SHEET NAME</b></p> <p align="center"><b>EROSION CONTROL DETAILS</b></p>	<p align="center"><b>PROJECT NAME</b></p> <p align="center">SHELBYVILLE PARKS &amp; REC. DEPT. MAINTENANCE BUILDING, BLUE RIVER PARK 1021 MORRIS AVE. SHELBYVILLE IN 46176</p>
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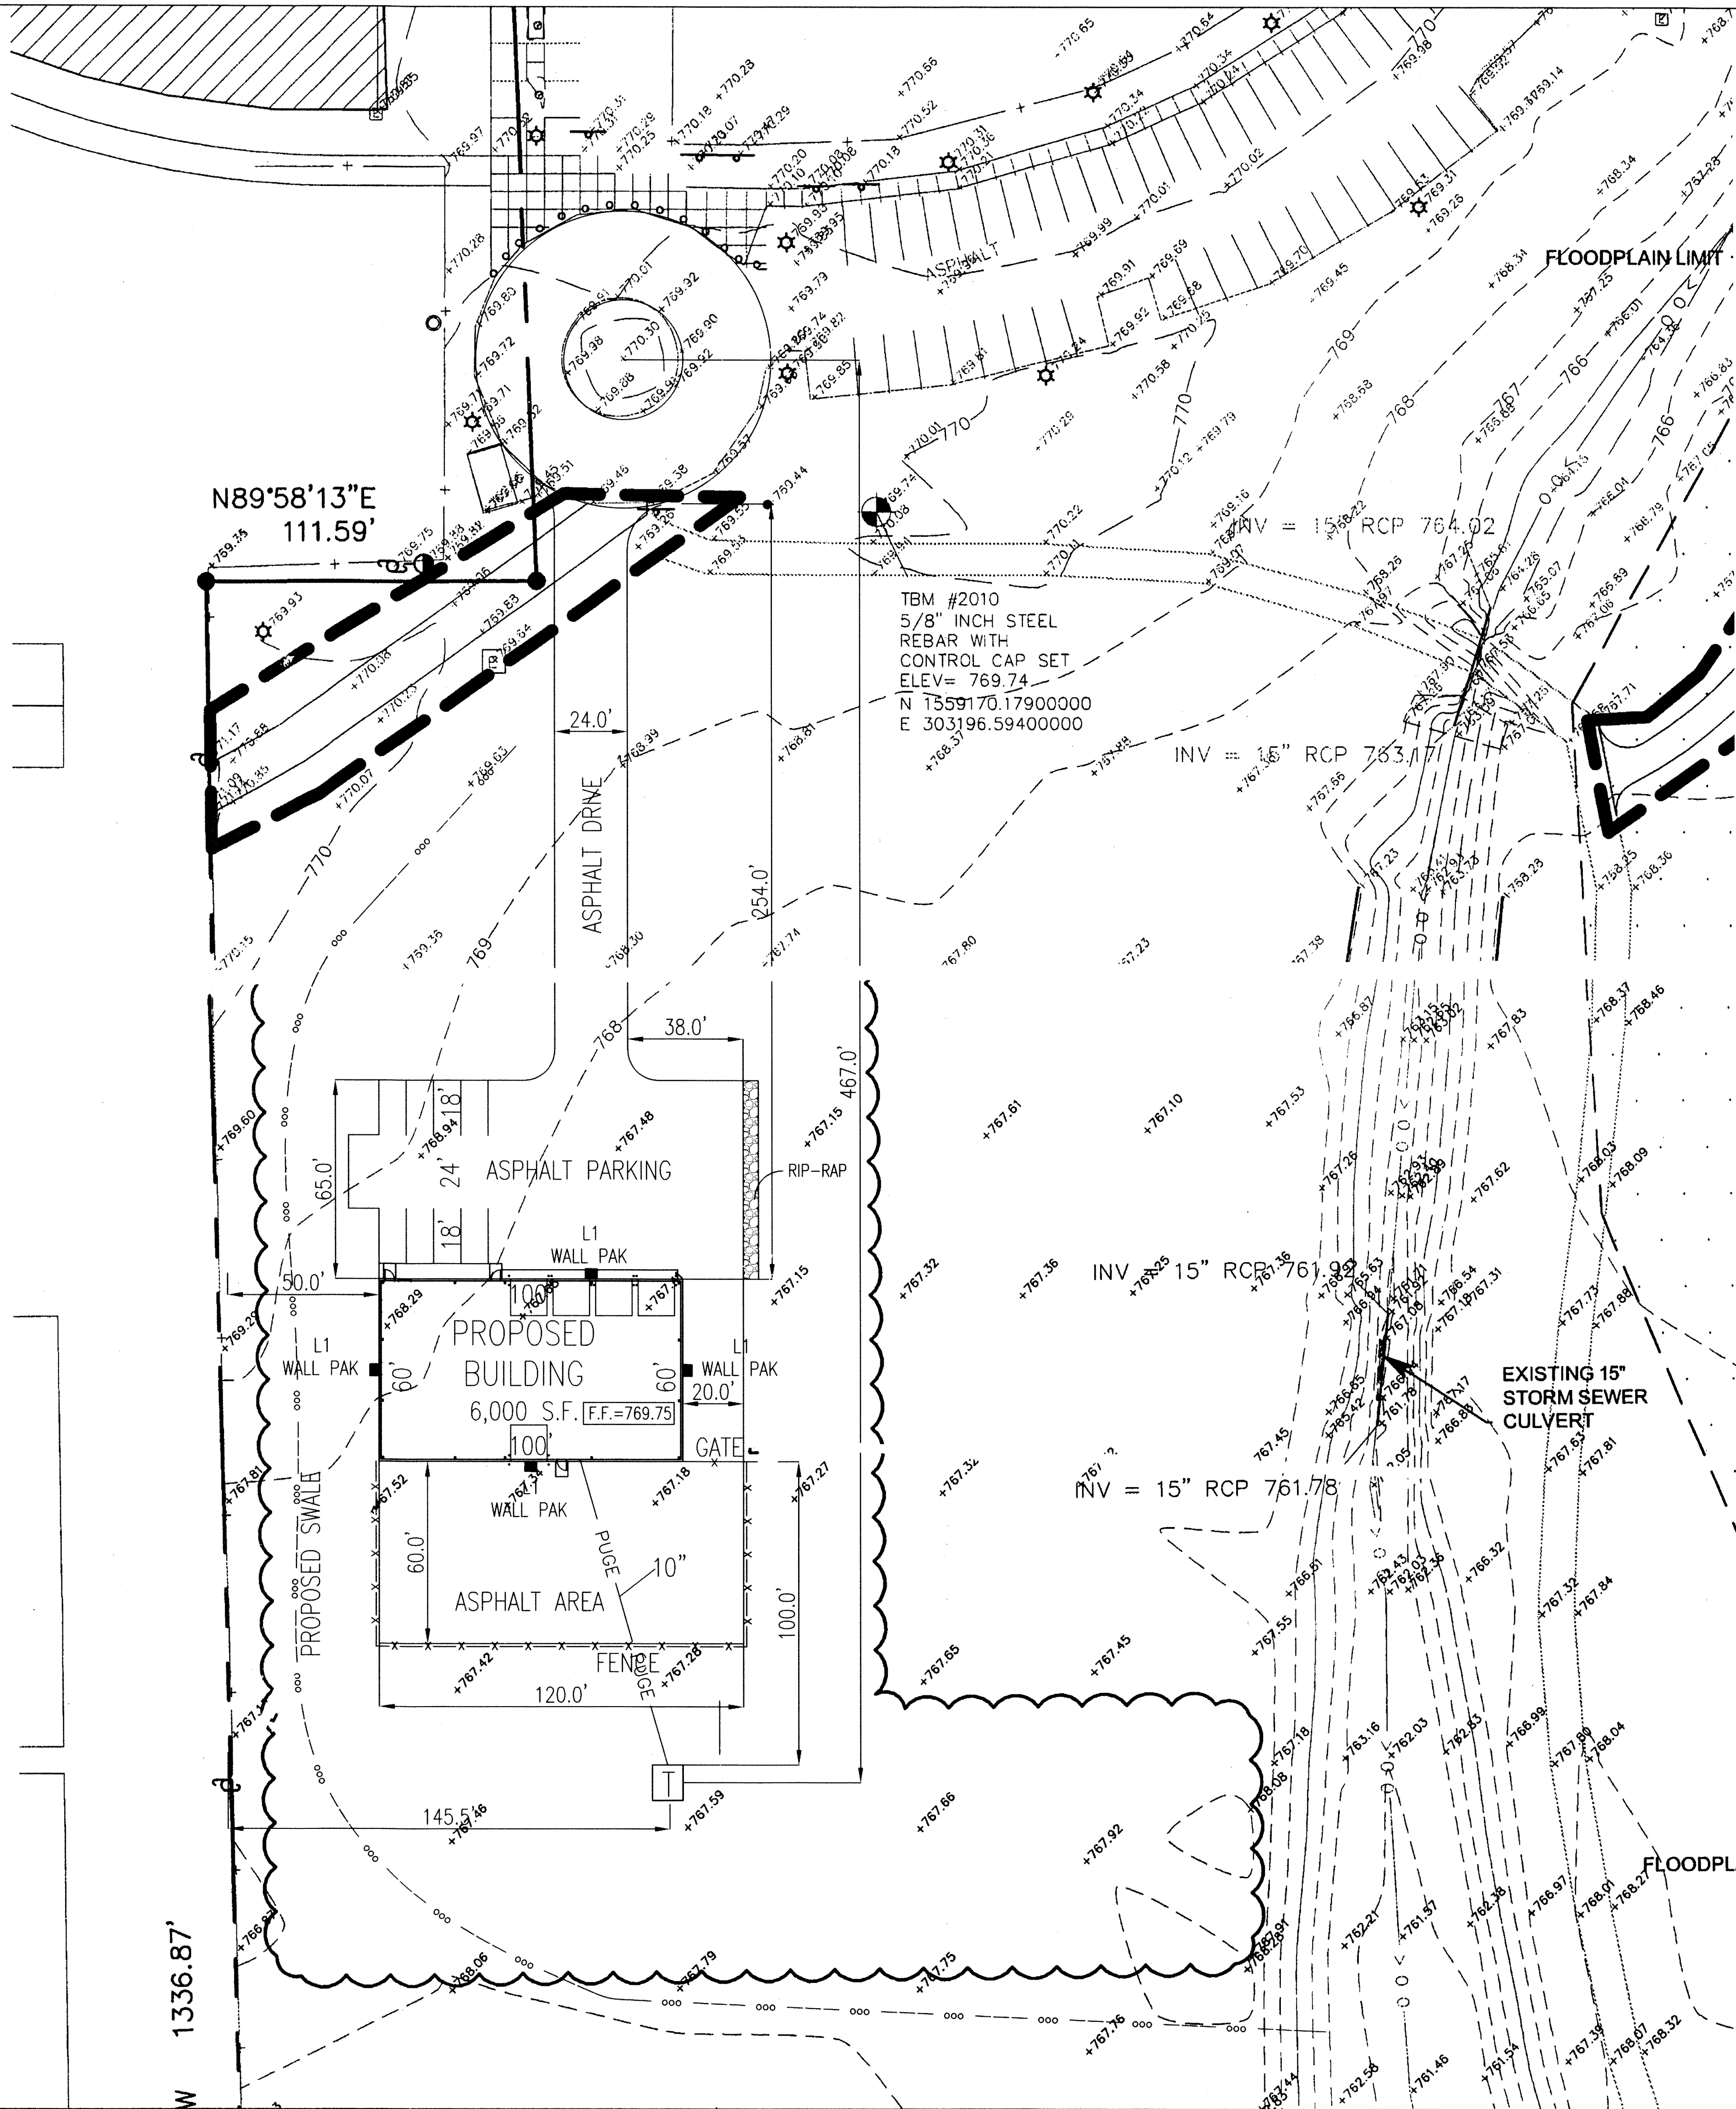
DATE: MAY 13, 2019

PROJECT NO.: 18015

SHEET NO.

C103





Project Name: \_\_\_\_\_ Part Number: \_\_\_\_\_ Type: \_\_\_\_\_

**FULL CUTOFF WALL PACK - 75W LED**  
OUTDOOR

**FEATURES**

- Bronze die-cast aluminum housing
- Custom and factory select colors available (Contact factory for pricing)
- Hinged full cutoff front frame
- 1/2" Conn plug with o-rings for conduit or optional photocell
- Forward throw optic lens
- Cast-in template for mounting directly over a 4" recessed outlet box
- 3000K, 4000K and 5000K color options
- ETL Listed for wet locations
- IK08 Dark Sky Approved
- Motion and daylight harvest available
- 5 Year warranty
- DesignLights Consortium® Qualified Luminaire

**SUITABLE APPLICATIONS**

- Parking Lots
- Loading Dock Areas
- Exterior Wall Lighting
- Building Entrance Ways

**LED SYSTEMS INFO**

	T2	T3	T4	T2	T3	T4
Calculated L <sub>vg</sub> (TM-21)	>100K	>100K	>100K	>100K	>100K	>100K
Delivered Lumens	8,767 lm	8,806 lm	8,344 lm	9,313 lm	9,141 lm	8,863 lm
Total Input Watts	74 W	74 W	74 W	74 W	74 W	74 W
Luminaire Efficacy Rating (LER)	119 lm/W	117 lm/W	113 lm/W	126 lm/W	124 lm/W	120 lm/W
Combined Color Temperature (CCT)	4000K	4000K	4000K	5000K	5000K	5000K
Color Rendering Index (CRI)	>70	>70	>70	>70	>70	>70
BUG Rating	B2 UD G2	B2 UD G2	B2 UD G2	B2 UD G2	B2 UD G2	B2 UD G2
Maximum Ambient Temperature	120 F	120 F	120 F	120 F	120 F	120 F
Universal Driver	120-277 V	120-277 V	120-277 V	120-277 V	120-277 V	120-277 V

**ORDERING GUIDE:**

Series	Watts	Driver	Color	Optics	Options
<input type="checkbox"/> WPCM Full Cutoff Wall Pack	<input type="checkbox"/> 75WLED	<input type="checkbox"/> UNIV 120-277V Driver	<input type="checkbox"/> 50 <input type="checkbox"/> 40 <input type="checkbox"/> 30	<input type="checkbox"/> T2 <input type="checkbox"/> T3 <input type="checkbox"/> T4	<input type="checkbox"/> WPC25WG Wire Guard, SS Construction <input type="checkbox"/> DD Dual Driver <input type="checkbox"/> PCxxx* Photocell (see "Notes") <input type="checkbox"/> SPI 15A Max ULNUL Surge Protector <input type="checkbox"/> SPI 20A Max ULNUL Surge Protector <input type="checkbox"/> FUSEIXXXX Single-line Voltage Fuse (120, 277, 347) <input type="checkbox"/> FUSEIDXXX Single-line Voltage Fuse (200, 240, 480) <input type="checkbox"/> WLOS Wet Location - Rated Occupancy Sensor <input type="checkbox"/> USBD User Select (3-Level Dim w/ Occ. Sensor) <input type="checkbox"/> BDxx Present BL-Level Dim Sensor (up to 20 ft) <input type="checkbox"/> BDxxPC Present BL-Level Dim Sensor w/ Photocell (up to 20 ft) <input type="checkbox"/> SP480V2 20A Max +40V Surge Protector <input type="checkbox"/> FULBCP65 65W LED Factory Installed Battery Backup <input type="checkbox"/> FULBCP7 7W LED Factory Installed Battery Backup <input type="checkbox"/> FULBCP10 10W LED Factory Installed Battery Backup <input type="checkbox"/> FULBCP12 12W LED Factory Installed Battery Backup <input type="checkbox"/> LEDBCT 10W Battery Backup <input type="checkbox"/> SD48V 48V Step Down Transformer <input type="checkbox"/> SD347V 347V Step Down Transformer

\* Photocell option available for field install.


**LIGHTING INVENTORY**

L1  
WALL PAK ■ ILP WPCM 75W LED UNV 40K WALL PACKS

**NOTES:**

SITE LIGHTING STANDARDS TO MEET CITY OF SHELBYVILLE UNIFIED DEVELOPMENT ORDINANCE 5.38.


ALL LIGHTING FIXTURES SHALL BE 90° CUT-OFF FIXTURE DIRECTED DOWNWARD AT THE GROUND SURFACE.

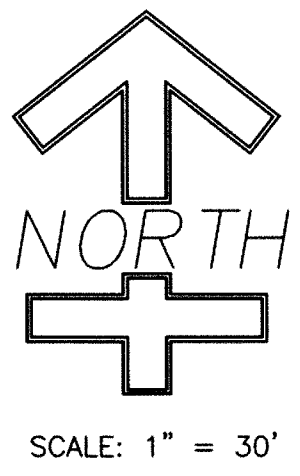

FOR BID PURPOSES ONLY



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BUILDING DESIGN, PLANNING  
6 East Taylor St. Shelbyville, IN 46176  
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www.spaceandsites.com  
e-mail: spaceandsites@sbcglobal.net

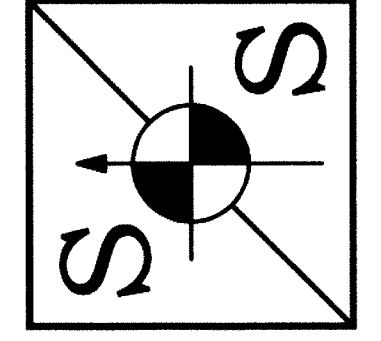

CHECKED	SYMBOL	REVISION	DATE
TN			
CERT.			
SCALE			
1"=30'			
DRAWN			
RC			

**SHEET NAME**  
PROPOSED SITE LIGHTING PLAN

**PROJECT NAME**  
SHELBYVILLE PARKS & REC. DEPT.  
MAINTENANCE BUILDING, BLUE RIVER PARK  
1021 MORRIS AVE., SHELBYVILLE, IN 46176



DATE: JUNE 10, 2019  
PROJECT NO.: 18015  
SHEET NO.  
C104



bioRxiv preprint doi: <https://doi.org/10.1101/2019.05.21.256411>; this version posted May 21, 2019. The copyright holder for this preprint (which was not certified by peer review) is the author/funder, who has granted bioRxiv a license to display the preprint in perpetuity. It is made available under aCC-BY-NC-ND 4.0 International license.

No individual building lots for this project.



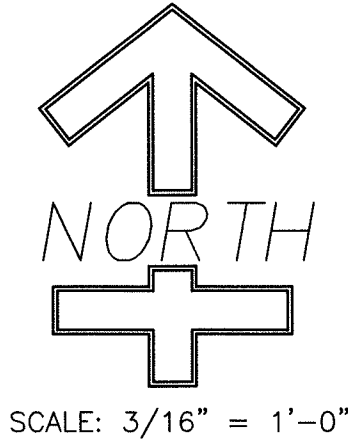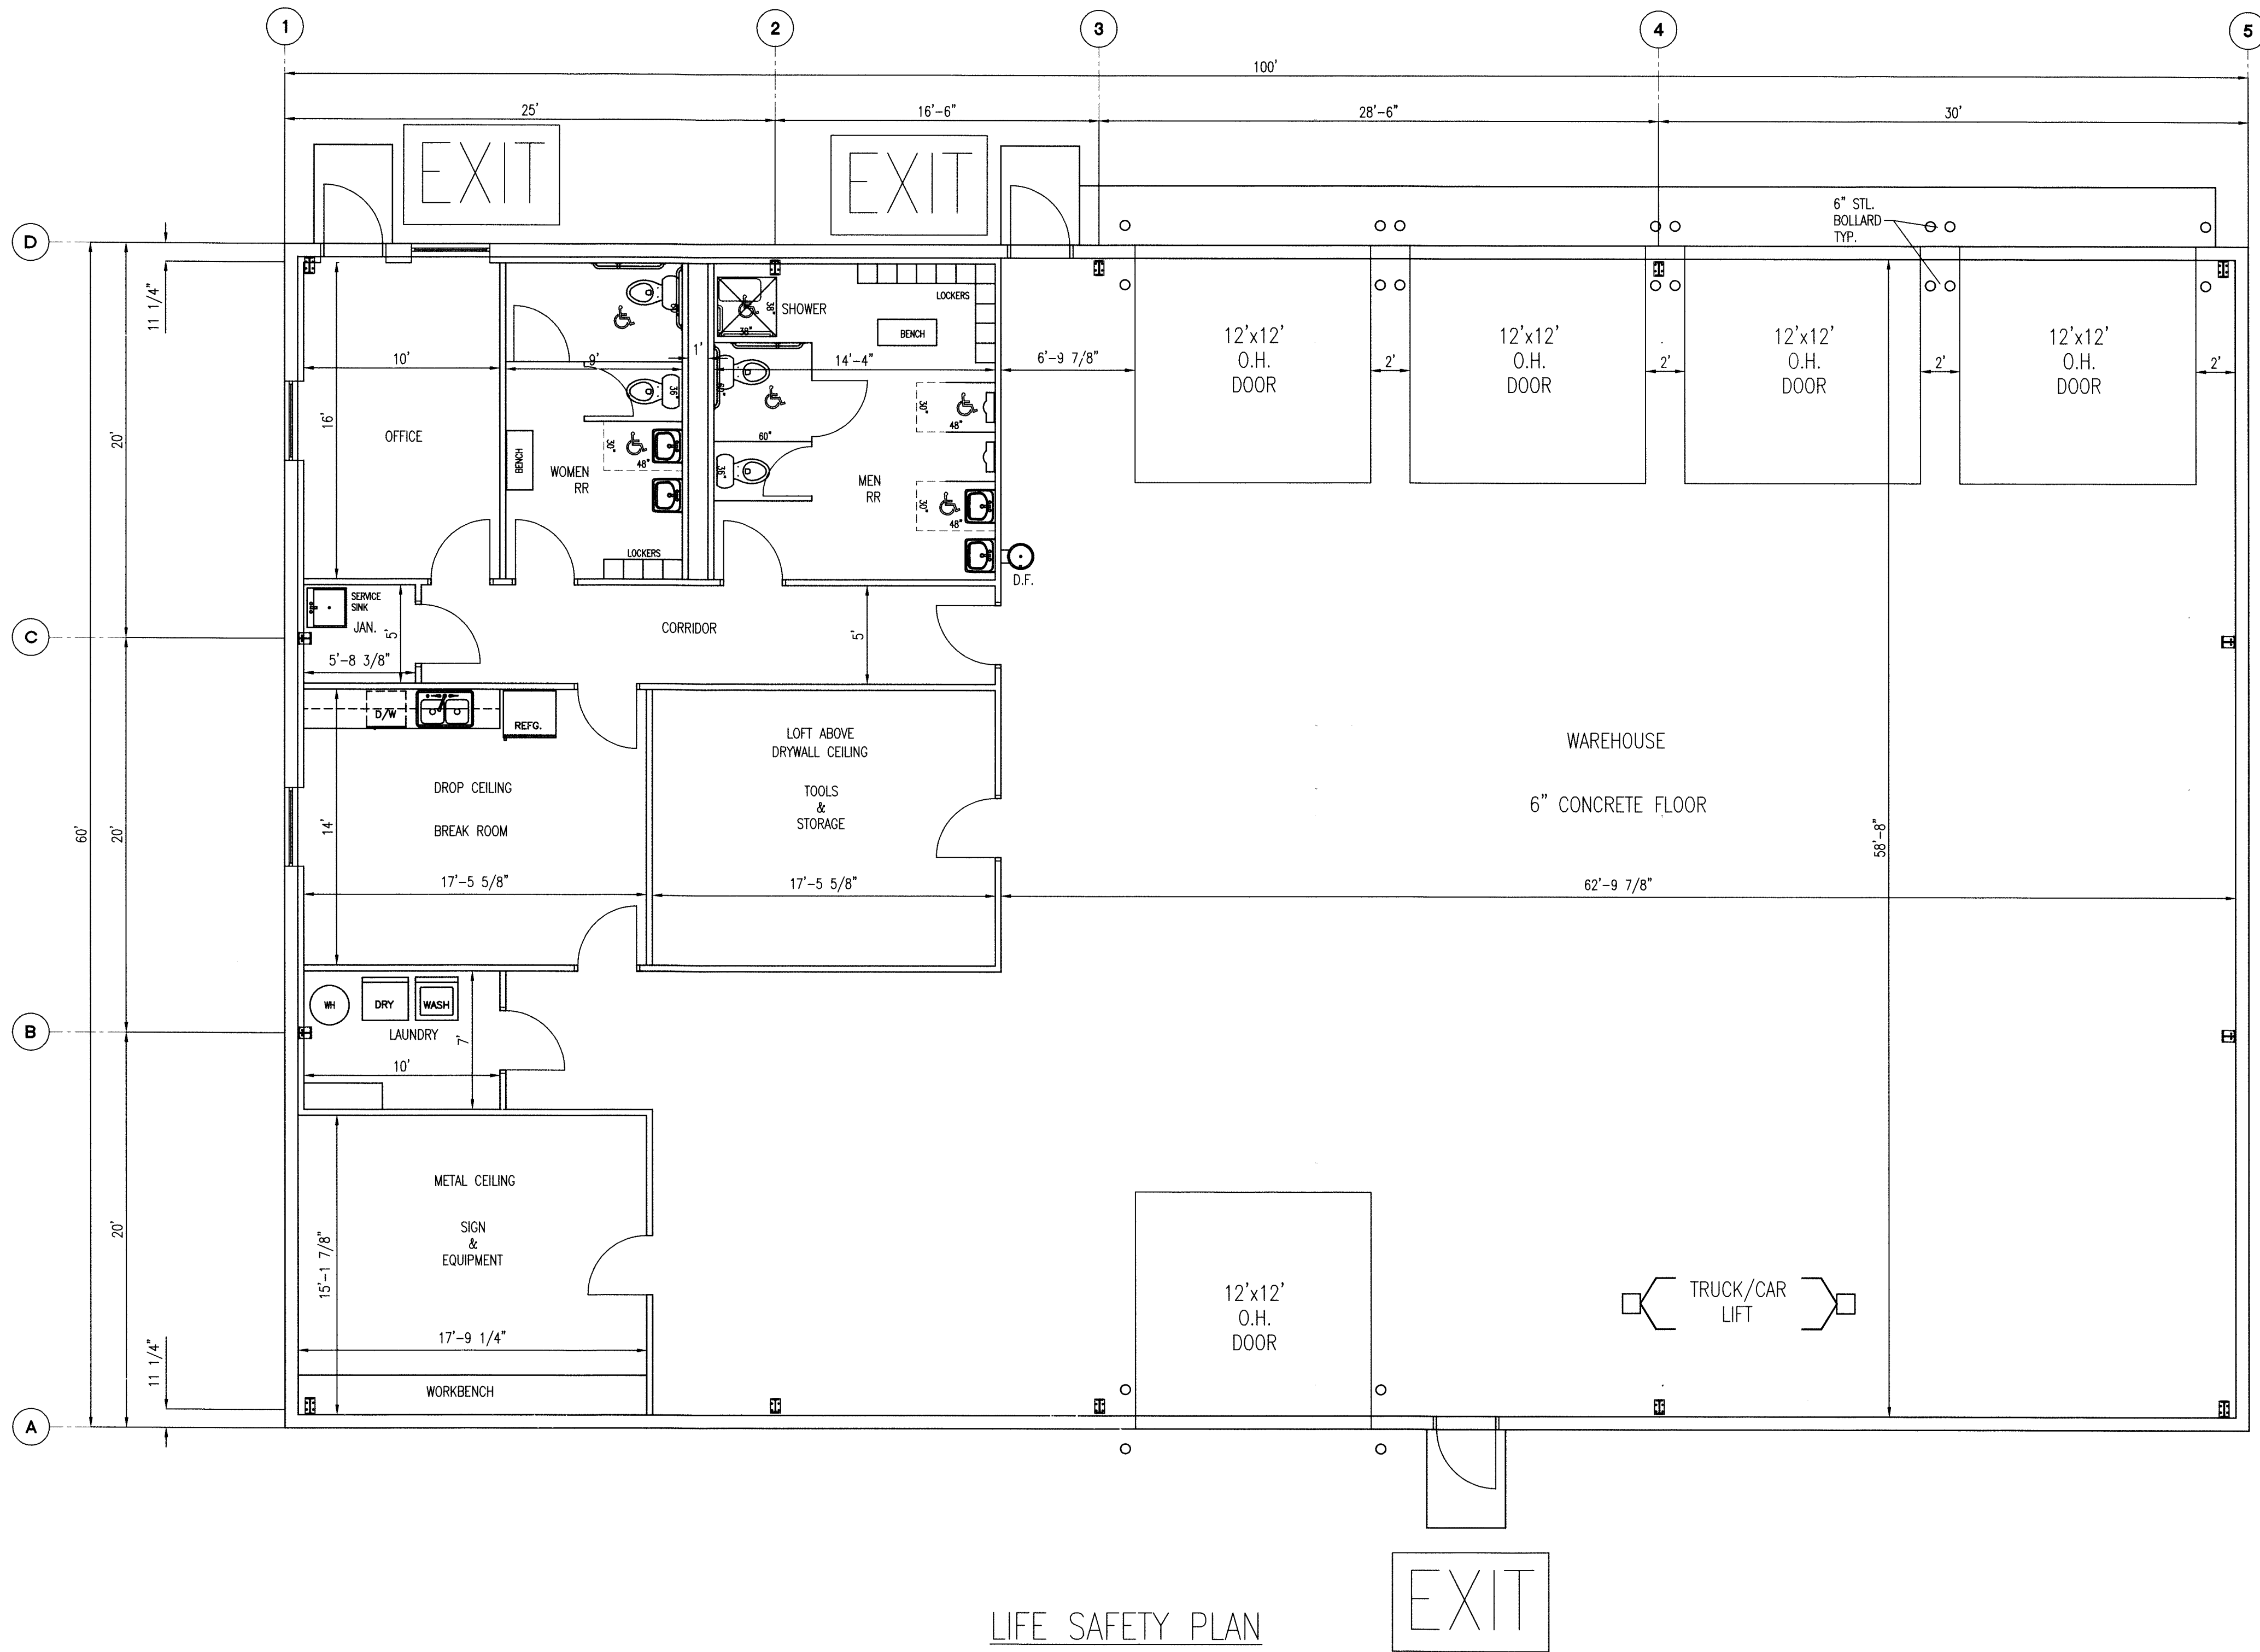

INDIANA BUILDING CODE:	2014 EDITION INDIANA
PLUMBING CODE:	2012 EDITION INDIANA
ELECTRICAL CODE:	2009 EDITION INDIANA
MECHANICAL CODE:	2014 EDITION INDIANA
ENERGY CONSERVATION CODE:	2010 ASHRAE 90.1, 2007 EDITION, AS AMENDED

CODE ANALYSIS

TENANT SPACE USE: OFFICE, MAINTENANCE, STORAGE

OCCUPANCY TYPE: B, S-2,

CONSTRUCTION TYPE: II-B,

BUILDING AREA: TOTAL=6,000 S.F.

FIRE SUPPRESSION SYSTEM: N/A

REQUIRED EXITS AND EXITS PROVIDED: 2 REQUIRED, 3 PROVIDED

BUILDING OCCUPANT LOAD:  
FACTORY: 200 GROSS PER S.F. = 7 OCCUPANTS  
STORAGE: 300 GROSS PER S.F. = 4 OCCUPANTS  
TOTAL OCCUPANTS = 87 OCCUPANTS

PLUMBING FIXTURES:  
WATER CLOSET- 1 PER 100 REQUIRED - 4 PROVIDED  
LAVATORIES- 1 PER 100 REQUIRED - 4 PROVIDED  
DRINKING FOUNTAINS- 1 PER 400 REQUIRED - 1 PROVIDED  
SERVICE SINK- 1 REQUIRED - 1 PROVIDED

- GENERAL NOTES:
1. ALL CONTRACTORS ARE TO VERIFY ALL DIMENSIONS PER THEIR WORK.
  2. ALL CONTRACTORS ARE TO CLEAN UP JOB SITE PER THEIR WORK.
  3. ALL CONTRACTORS ARE TO VERIFY ALL APPLICABLE LOCAL CODES OR ORDINANCES PER THEIR WORK.
  4. OWNER SHALL APPROVE ALL SHOP DRAWINGS REQUIRED OF THE PROJECT.
  5. NOTIFY OWNER OF ANY CHANGES REQUIRED PER THESE GENERAL NOTES.
  6. ALL ELECTRICAL AND HVAC LOCATIONS BY OWNER AND BUILDER.
  7. ALL INTERIOR FINISHES AND MATERIALS SELECTED BY OWNER AND BUILDER.
  8. ALL FINISHES AND UNFINISHED AREAS TO BE CERTIFIED BY MANUFACTURER/SUPPLIER.
  9. ALL STEEL TO BE CERTIFIED BY MANUFACTURER/SUPPLIER.
  10. WINDOW SELECTION BY OWNER AND BUILDER.
  11. PROVIDE SMOKE DETECTORS AND FIRE EXTINGUISHERS AS REQUIRED BY STATE AND LOCAL CODES.
  12. DOOR SELECTION BY OWNER AND BUILDER (SIZE AND TYPE).



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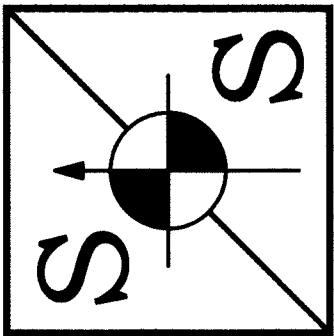
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CHECKED	SYMBOL	REVISION	DATE
TN		REVISED-OCCUPANCY TYPES, AREAS	3/22/19
CERT.			
SCALE			
3/16"=1'			
DRAWN			
RC			


SHEET NAME	PROJECT NAME
LIFE SAFETY PLAN	SHELBYVILLE PARKS & REC. DEPT. MAINTENANCE BUILDING, BLUE RIVER PARK 1021 MORRIS AVE., SHELBYVILLE, IN 46176

DATE: MAY 13, 2019

PROJECT NO.: 18015

SHEET NO.


G100

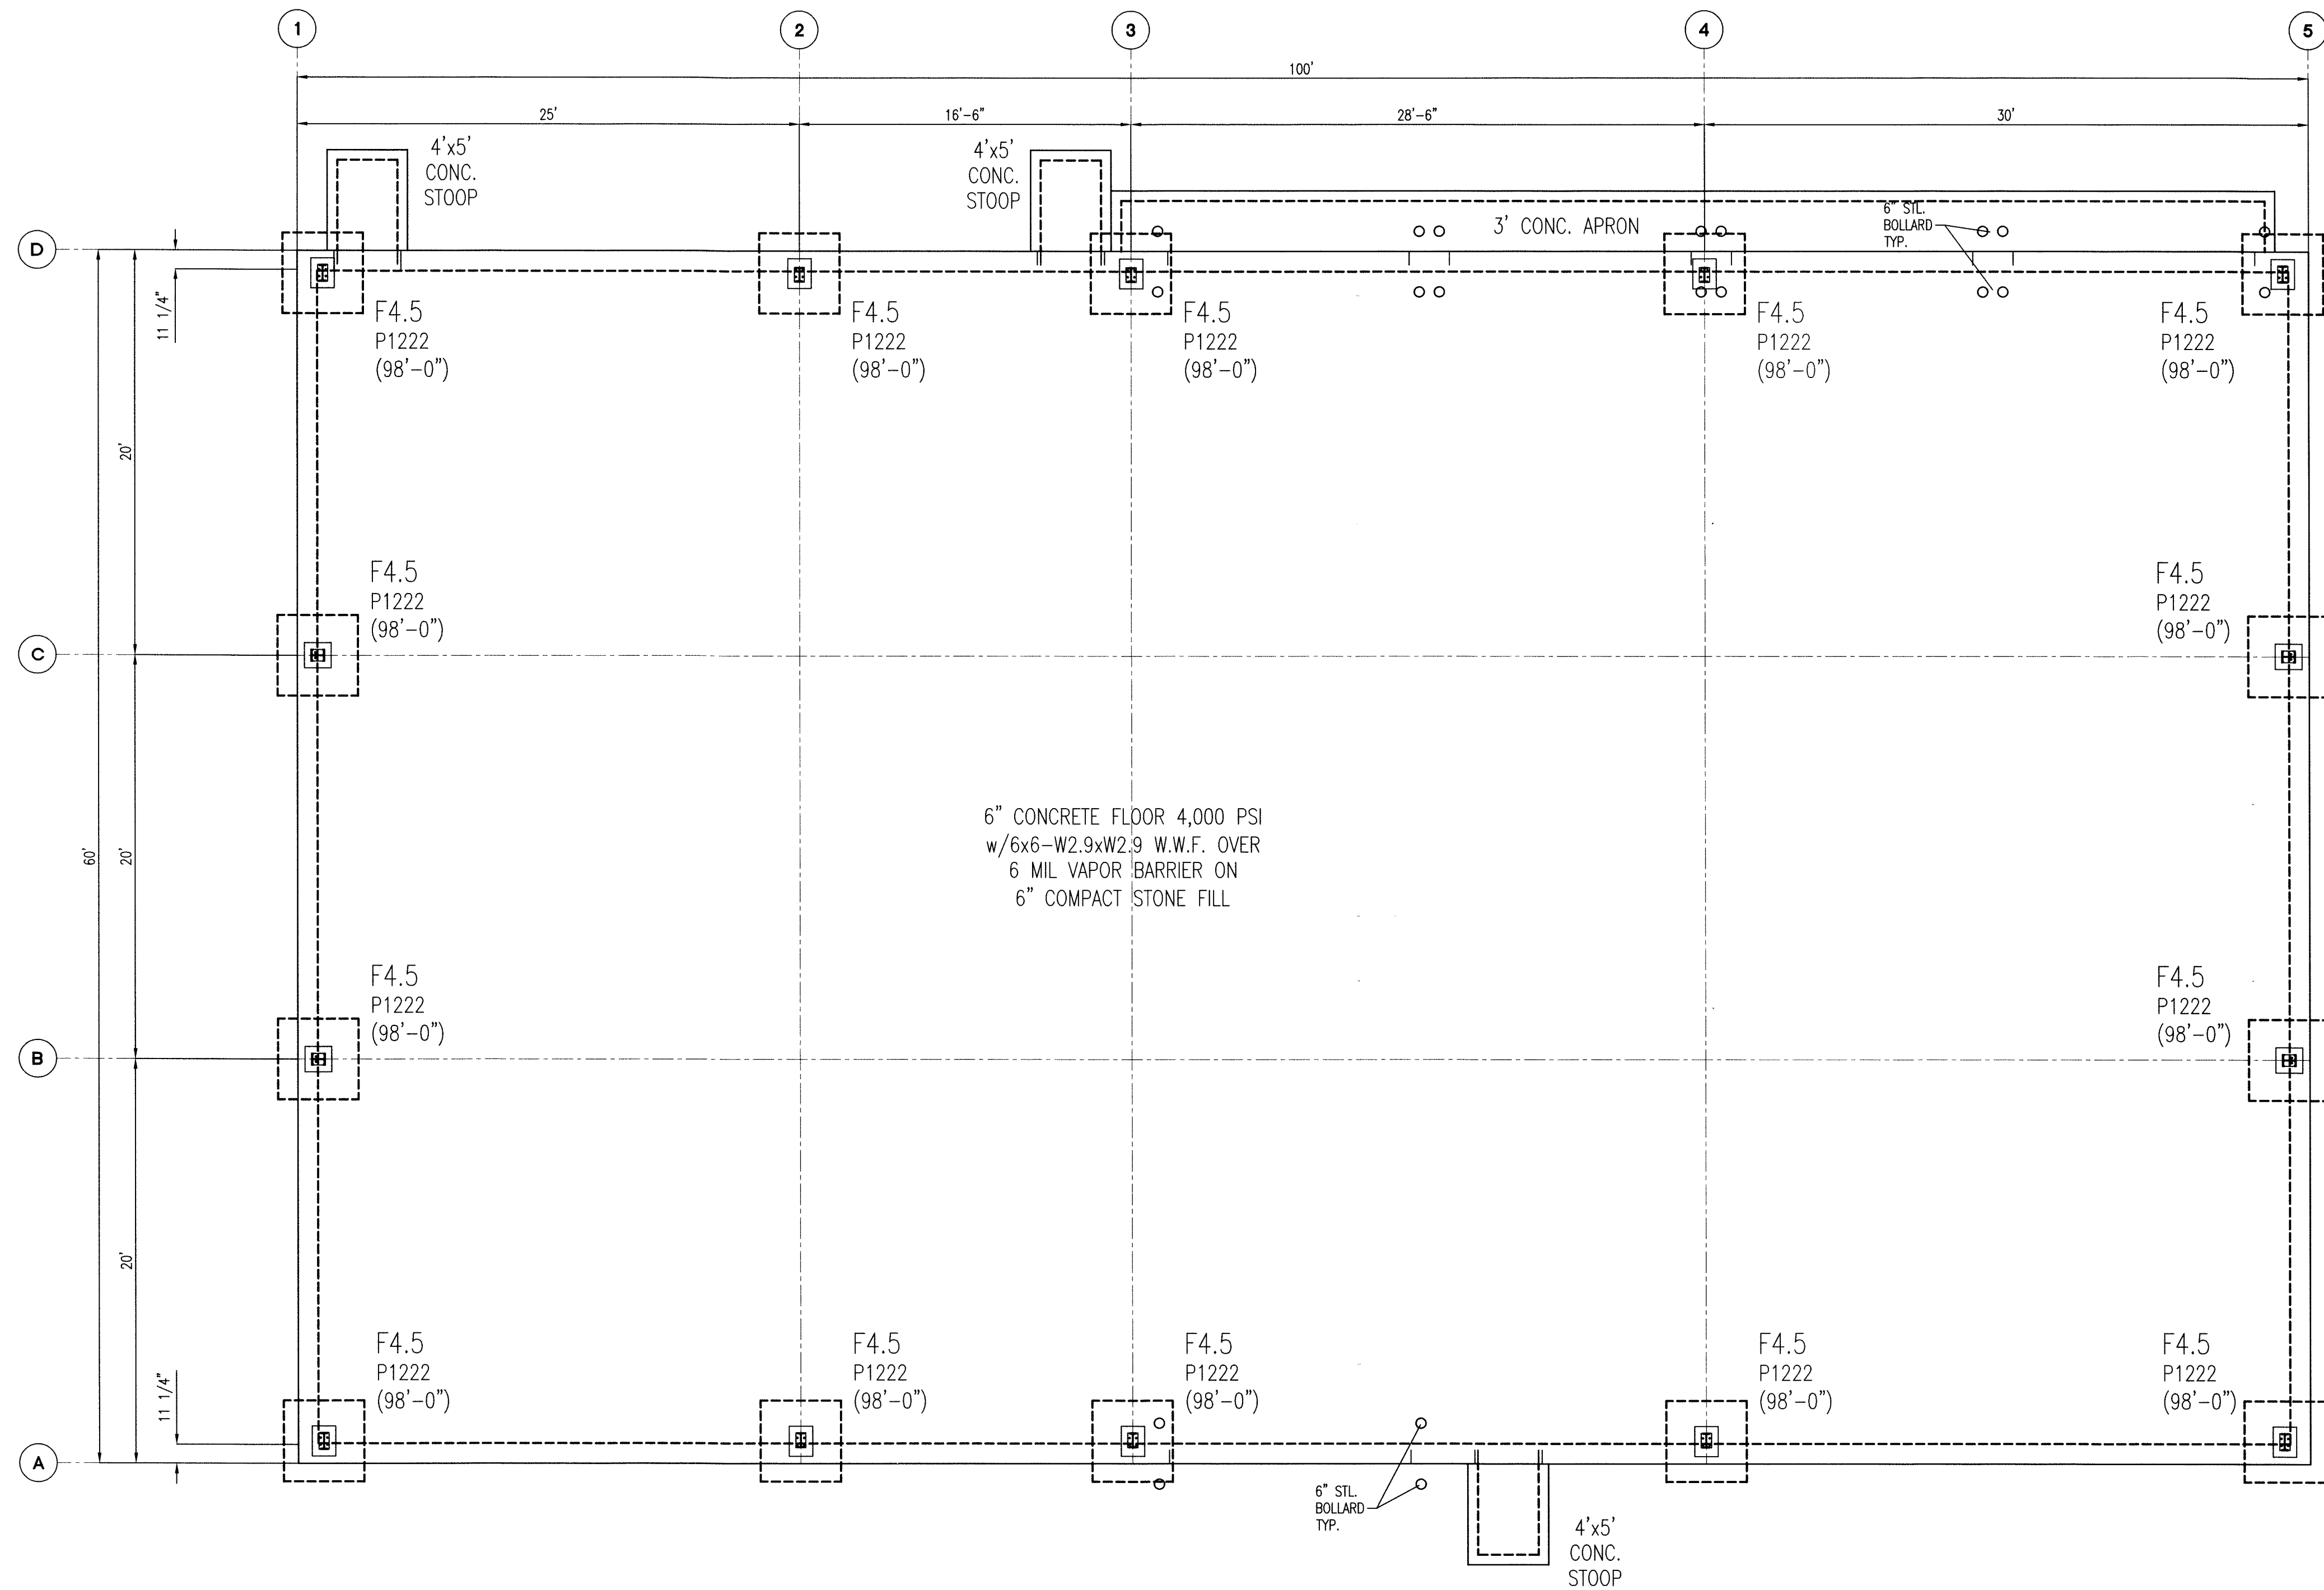

PROPOSED FOUNDATION PLAN

NOTE:  
FOUNDATION FOR BIDDING PURPOSES ONLY.  
ACTUAL SIZE PER STEEL MANUFACTURE REACTIONS.

NOTES:  
  
ALL WORK SHALL BE PREFORMED BY  
QUALIFIED PERSONNEL PER THEIR  
TRADE WITH QUALITY WORKMANSHIP  
AND PER CODES THAT APPLY THAT  
MAY OR MAY NOT BE SHOWN ON  
PLANS.  
  
BLOCK WALLS TO HAVE #5 REBARS  
32" O.C. w/DURAWALL @ 16" O.C.,  
(2) BOND BEAMS, ABOVE WINDOWS  
AND TOP COURSE, FOAM CORES,  
SEAL AND PAINT BLOCK

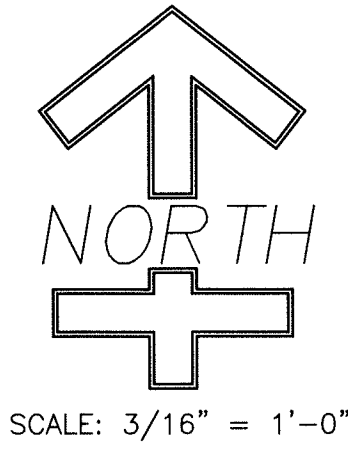

FOR BID PURPOSES ONLY



SPACE and SITES, LLC


ENGINEERING, BUILDING DESIGN

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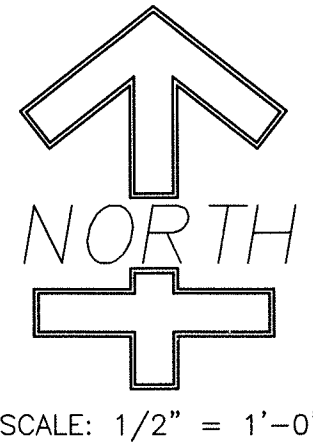


CHECKED	SYMBOL	REVISION	DATE
IN			
CERT.			
SCALE			
3/16"=1'			
DRAWN			
RC			

SHEET NAME	PROJECT NAME
PROPOSED FOUNDATION PLAN	SHELBYVILLE PARKS & REC. DEPT. MAINTENANCE BUILDING, BLUE RIVER PARK 1021 MORRIS AVE., SHELBYVILLE, IN 46176

DATE: MAY 13, 2019
PROJECT NO.: 18015
SHEET NO.
S100

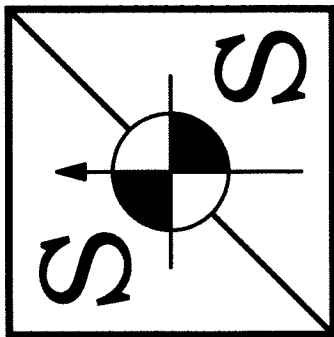- GENERAL NOTES:
1. ALL CONTRACTORS ARE TO VERIFY ALL DIMENSIONS PER THEIR WORK.
  2. ALL CONTRACTORS ARE TO CLEAN UP JOB SITE PER THEIR WORK.
  3. ALL CONTRACTORS ARE TO VERIFY ALL APPLICABLE LOCAL CODES OR ORDINANCES PER THEIR WORK.
  4. NOTIFY OWNER OF ANY CHANGES REQUIRED PER THESE GENERAL NOTES.
  5. OWNER SHALL APPROVE ALL SHOP DRAWINGS REQUIRED OF THIS PROJECT.
  6. ALL INTERIOR FINISHES AND MATERIALS SELECTED BY OWNER AND BUILDER.
  7. ALL ELECTRICAL AND HVAC LOCATIONS BY OWNER AND BUILDER.
  8. ALL DOORS AND WINDOW BEAMS TO BE CERTIFIED BY MANUFACTURER/SUPPLIER.
  9. ALL STEEL TO BE CERTIFIED BY MANUFACTURER/SUPPLIER.
  10. WINDOW SELECTION BY OWNER AND BUILDER.
  11. PROVIDE SMOKE DETECTORS AND FIRE EXTINGUISHERS AS REQUIRED BY STATE AND LOCAL CODES.
  12. DOOR SELECTION BY OWNER AND BUILDER (SIZE AND TYPE).



GENERAL NOTES:


- THE STRUCTURAL DRAWINGS INDICATE THE GENERAL SCOPE OF THE PROJECT IN TERMS OF STRUCTURAL DESIGN CONCEPT, THE DIMENSIONS OF THE BUILDING, AND MAJOR STRUCTURAL ELEMENTS. AS SCOPE DOCUMENTS, THE DRAWINGS DO NOT NECESSARILY INDICATE OR DESCRIBE IN DETAIL ALL WORK REQUIRED FOR FULL PERFORMANCE AND COMPLETION OF THE STRUCTURAL REQUIREMENTS. BASED ON THE GENERAL SCOPE INDICATED AND DESCRIBED, THE CONTRACTORS SHALL FURNISH ALL ITEMS REQUIRED FOR THE PROPER EXECUTION AND COMPLETION OF THE PROJECT. ALL REQUESTS FOR INTERPRETATION (RFI) ARE TO BE SUBMITTED IN WRITING.
- WALSH ENGINEERING SERVICES, P.C. REVIEW OF SHOP DRAWINGS IS TO VERIFY THE CONTRACTOR'S INTERPRETATION AND COMPLIANCE TO THE CONTRACT DOCUMENTS. WALSH ENGINEERING SERVICES, P.C. IS NOT RESPONSIBLE FOR QUANTITIES, DIMENSIONS, FIT, ERECTION REQUIREMENTS OR SEQUENCES AND EXISTING OR AS-BUILT CONDITIONS. ALLOW TWO WEEKS FOR SHOP DRAWING REVIEW.
- THE PURPOSE OF WALSH ENGINEERING SERVICES, P.C. SITE VISITATIONS IS TO BECOME FAMILIAR WITH THE PROGRESS, QUALITY OF CONSTRUCTION AND COMPLIANCE WITH THE CONTRACT DOCUMENTS. THE SITE VISITATIONS BY WALSH ENGINEERING SERVICES, P.C. DOES NOT INCLUDE INSPECTIONS OR CONSTRUCTION MANAGEMENT AND PROVIDES NO GUARANTEE OF THE WORK OR MATERIALS.
- THE INFORMATION CONTAINED HEREIN IS THE EXCLUSIVE PROPERTY OF WALSH ENGINEERING SERVICES, P.C., AND IS THEREBY PROTECTED UNDER COPYRIGHT LAWS. THE ORIGINAL IDEAS REPRESENTED HEREIN BY THIS INFORMATION SHALL NOT BE USED, ALTERED OR REPRODUCED IN ANY MANNER WITHOUT THE EXPRESSED WRITTEN CONSENT OF WALSH ENGINEERING SERVICES, P.C. AUTO-CAD DRAWINGS ARE COVERED UNDER COPYRIGHT LAWS. FOR USE OF AUTO-CAD DRAWINGS IN PREPARATION OF SHOP DRAWINGS A FEE IS REQUIRED. CONTACT WALSH ENGINEERING SERVICES, P.C. FOR ADDITIONAL INFORMATION.
- BUILDING CODES:  
INTERNATIONAL BUILDING CODE, 2012 WITH INDIANA AMENDMENTS  
AMERICAN INSTITUTE OF STEEL CONSTRUCTION, ASD  
AMERICAN CONCRETE INSTITUTE, 318
- DESIGN LOADS:  
RISK CATEGORY II
- SECTIONS INDICATED AS TYPICAL MAY NOT BE INDICATED ON PLAN SHEETS. IT IS THE CONTRACTORS' RESPONSIBILITY TO USE TYPICAL SECTIONS WHERE REQUIRED.
- CONTRACTORS ARE RESPONSIBLE FOR PROVIDING TEMPORARY BRACING AND/OR SHORING UNTIL THE PERMANENT BRACING IS IN PLACE.
- ALL CONTRACTORS ARE REQUIRED TO COORDINATE THEIR WORK WITH ALL DISCIPLINES TO AVOID CONFLICTS. SEE MECHANICAL, ELECTRICAL AND PLUMBING DRAWINGS FOR ADDITIONAL INFORMATION REGARDING SIZE AND QUANTITY OF OPENINGS, SLAB REQUIREMENTS AND LINTELS.
- IF A CONFLICT EXISTS BETWEEN CONTRACT DOCUMENTS, THE MORE STRINGENT CONDITION IS TO BE USED, UNLESS NOTED OTHERWISE.
- SUPPORTS NOT SHOWN AND REQUIRED FOR NON-STRUCTURAL ITEMS AND THEIR APPURTENANCES ARE TO BE PROVIDED BY THE CONTRACTOR REQUIRING THE NON-STRUCTURAL ITEM.
- VERIFY ALL EXISTING CONDITIONS PRIOR TO ANY CONSTRUCTION OR FABRICATION. IF CONDITIONS ARE DIFFERENT THAN SHOWN, NOTIFY ENGINEER/ARCHITECT IMMEDIATELY FOR MODIFICATIONS.
- METAL BUILDING MANUFACTURER SHALL SUBMIT COLUMN LOADING FOR ENGINEER TO REVIEW. PIER AND FOOTING SIZES MAY BE SUBJECT TO CHANGE DUE TO THE LOADING CONDITIONS SUPPLIED BY THE METAL BUILDING MANUFACTURER.

FOUNDATION NOTES:

- AN ASSUMED ALLOWABLE SOIL BEARING PRESSURE IS 2000 PSF, TO BE VERIFIED BY CONTRACTOR. REFER TO TYPICAL SECTION FOR FOUNDATION SUPPORT AT UNSUITABLE SOIL AREAS. FLOWABLE FILL SHALL HAVE A MINIMUM CONCRETE COMPRESSIVE STRENGTH OF  $f_c=50$  PSI.
- FOOTINGS ARE TO BE PLACED ON UNDISTURBED NATURAL SOIL, ENGINEERED FILL OR FLOWABLE FILL. PREVIOUS UNCONTROLLED FILL MATERIAL IS NOT ACCEPTABLE.
- ENGINEERED FILL SHALL BE FREE OF ORGANIC MATERIAL, ROCKS LARGER THAN 2 INCHES, AND CLAY SHALL NOT HAVE A PI GREATER THAN 15. FILL SHALL BE COMPACTED TO A MINIMUM 95% OF THE MAXIMUM MODIFIED PROCTOR PER ASTM-D1557, AND PLACED IN 8 INCH LIFTS.
- GRANULAR MATERIAL IS SOIL WITH A ROUNDED SHAPE, FREE OF ORGANIC AND CLAY MATERIAL CONFORMING TO ASTM C33 SIZE #67 (3/4" MAXIMUM SIZE OF AGGREGATE) OR INDOT #8.

CONCRETE NOTES:

- ALL CONCRETE SHALL HAVE THE FOLLOWING 28 DAY COMPRESSIVE STRENGTHS:  
FOOTINGS 3000 PSI WITH 2% AIR ENTRAINMENT, W/C=55  
EXTERIOR SLABS 4000 PSI WITH 6% AIR ENTRAINMENT, W/C=45  
INTERIOR SLABS 4000 PSI WITH 2% AIR ENTRAINMENT, AND W/C=5
- ALL REINFORCING STEEL SHALL BE ASTM A-615 GRADE 60. ALL WELDED WIRE FABRIC SHALL BE ASTM A185 WITH YIELD OF 65 KSI.
- ALL CONCRETE AGGREGATE SHALL CONFORM WITH ASTM C33 WITH NOMINAL MAXIMUM COURSE AGGREGATE SIZE OF 1 INCH AND WITHOUT CHERT WHERE EXPOSED TO PUBLIC VIEW.
- ALL CONCRETE SHALL USE TYPE I PORTLAND CEMENT. REPLACEMENT OF PORTLAND CEMENT WITH CLASS "C" FLY ASH IS ALLOWED UP TO 20 PERCENT. IN FOOTINGS ONLY, SLAG CAN BE USED TO REPLACE PORTLAND CEMENT UP TO 30 PERCENT.
- PROVIDE SLEEVES FOR ALL OPENINGS IN GRADE BEAMS, TO SEPARATE PIPE FROM CONCRETE.
- CONCRETE WORK SHALL CONFORM TO ALL REQUIREMENTS OF ACI 301, SPECIFICATIONS FOR STRUCTURAL CONCRETE FOR BUILDINGS. AND ACI 347, GUIDE TO FORMWORK FOR CONCRETE.
- ALL REINFORCEMENT SHALL BE PLACED PER THE CONCRETE REINFORCING STEEL INSTITUTE, MANUAL OF STANDARD PRACTICE.
- PROVIDE 1" DEEP BY 1/4" WIDE CONTROL JOINTS AT 10 FEET MAXIMUM IN SLABS ON GRADE, FILL JOINT WITH MASTERSEAL CR190 OR EQUAL. CONTRACTOR TO LOCATE AT A MINIMUM ON GRID LINES AND IN A 1 TO 1.5 MAXIMUM RECTANGLE, CUT AS SOON AS CONCRETE WILL SUPPORT EQUIPMENT.
- PROVIDE 3/4" CHAMFERS ON ALL EXPOSED EDGES OF CONCRETE.
- MINIMUM CONCRETE COVER OVER REINFORCEMENT IS AS FOLLOWS, UNLESS NOTED OTHERWISE:  
CONCRETE CAST AGAINST EARTH 3"  
CONCRETE EXPOSED TO EARTH OR WEATHER 2"  
INTERIOR CONCRETE SLABS 3/4"
- EXPANSION JOINT MATERIAL IS TO COMPLY WITH ASTM D1751 (ASPHALT-SATURATED CELLULOSE FIBER).
- UNLESS NOTED OTHERWISE ALL LAPS SHALL BE 72 BAR DIAMETERS..


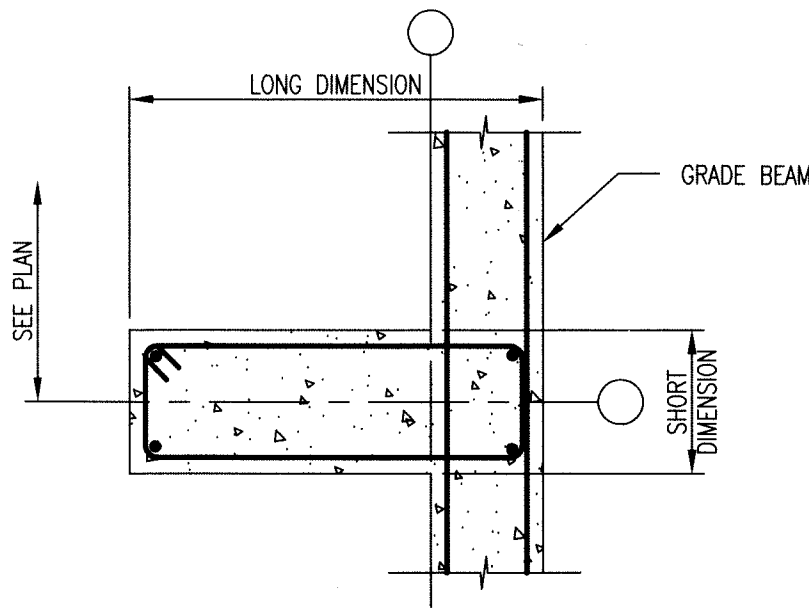


TYPICAL EXTERIOR METAL BUILDING COLUMN PIER PLAN DETAIL  
scale: 1/2"=1'-0"


PIER SCHEDULE		
MARK	SIZE	REINFORCEMENT
P1222	1'-10" x 1'-4"	4-#6 HOOKED VERTICAL DOWELS AND #3 TIES @ 12"

FOOTING SCHEDULE		
MARK	SIZE	REINFORCEMENT
F2	2'-0"x2'-0"x1'-0"	#5 @ 12" EACH WAY
F3.5	3'-6" x 3'-6" x 1'-0"	#5 @ 12" EACH WAY
F4.5	4'-6" x 4'-6" x 1'-0"	#5 @ 12" EACH WAY


LEGEND

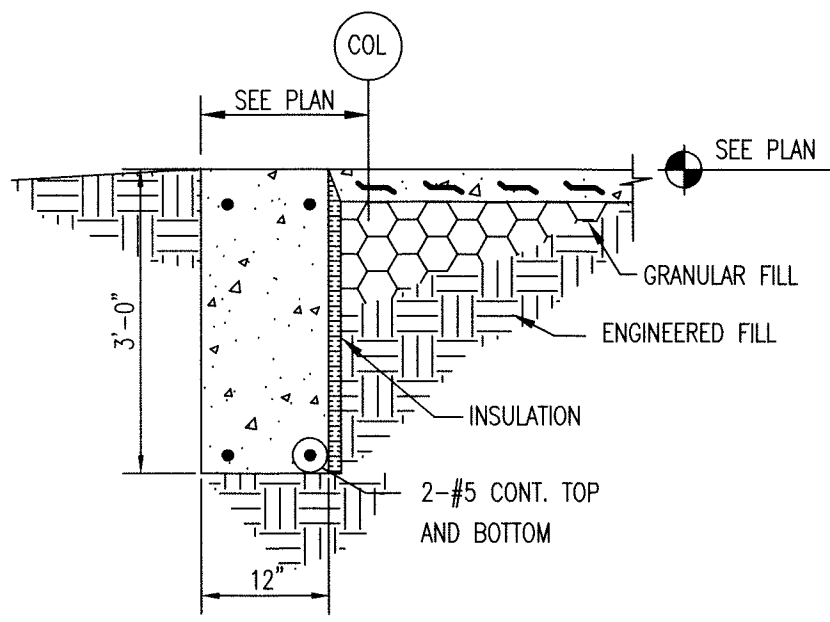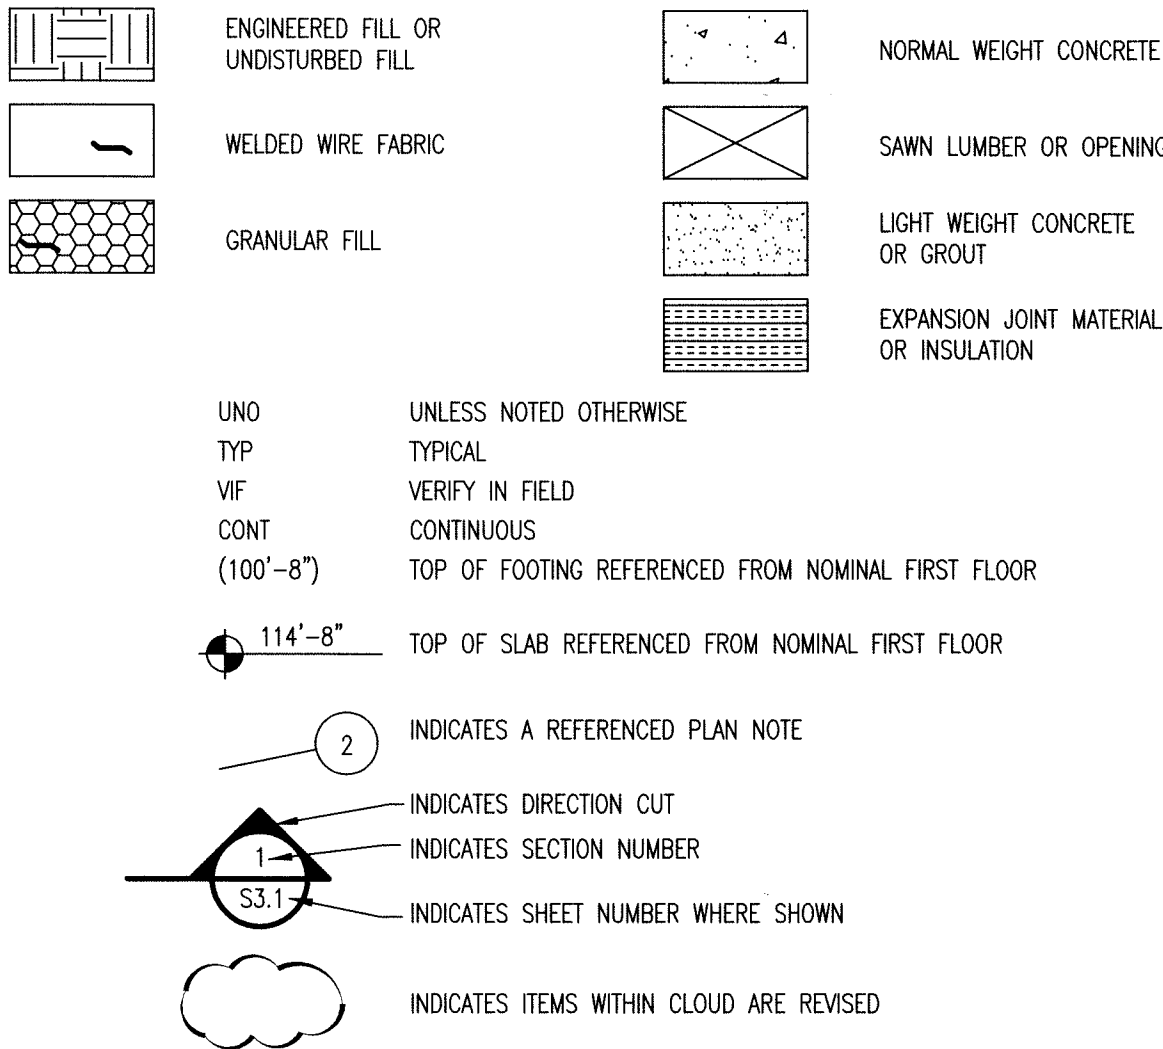


TYPICAL EXTERIOR WALL SECTION  
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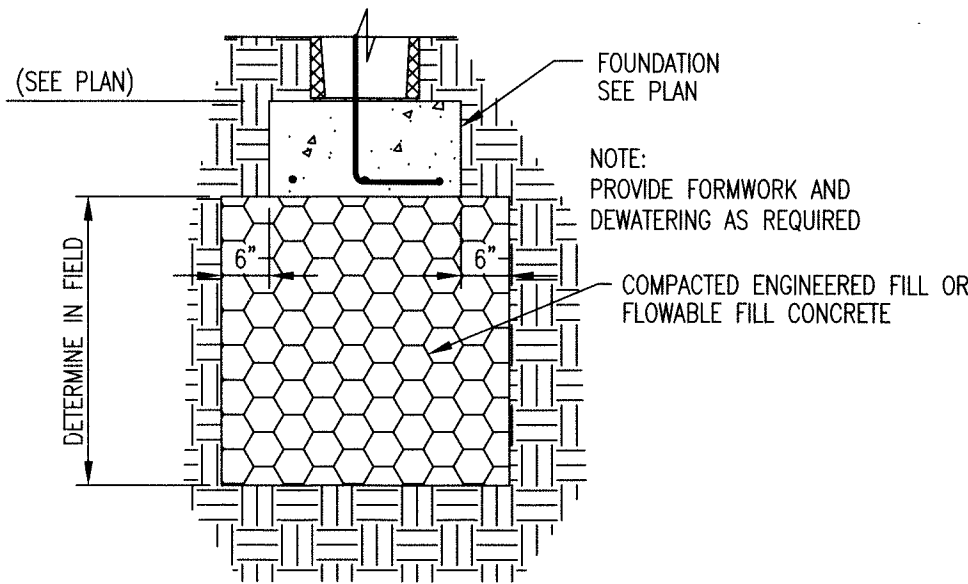
TYPICAL EXTERIOR COLUMN SECTION  
scale: 1/2"=1'-0"

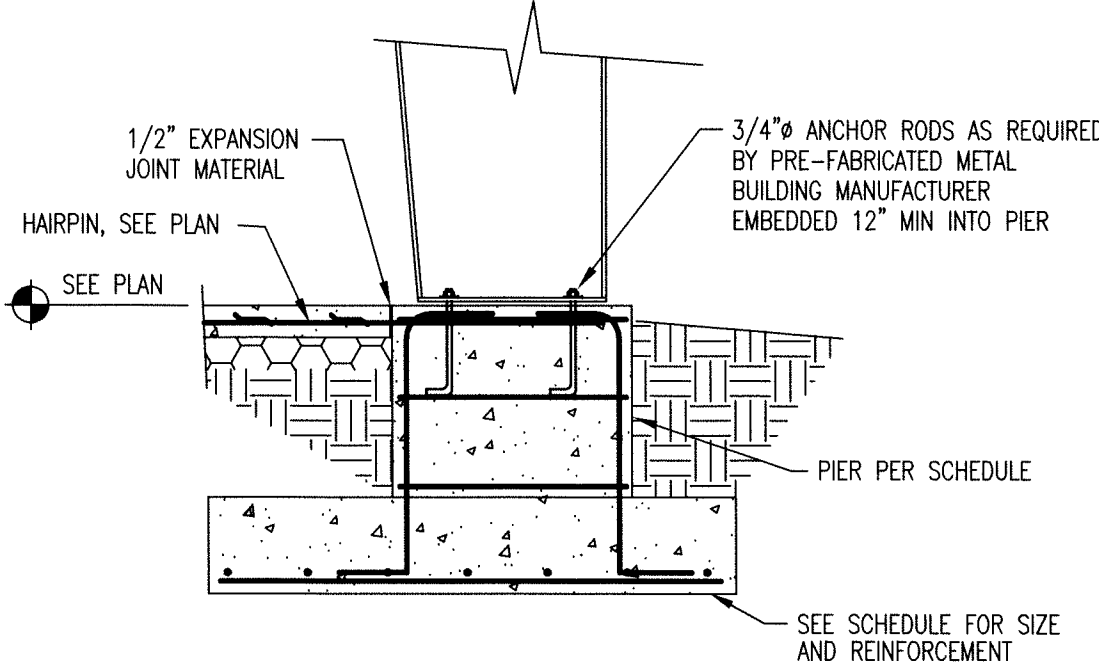

TYPICAL ENTRY SECTION  
scale: 1/2"=1'-0"

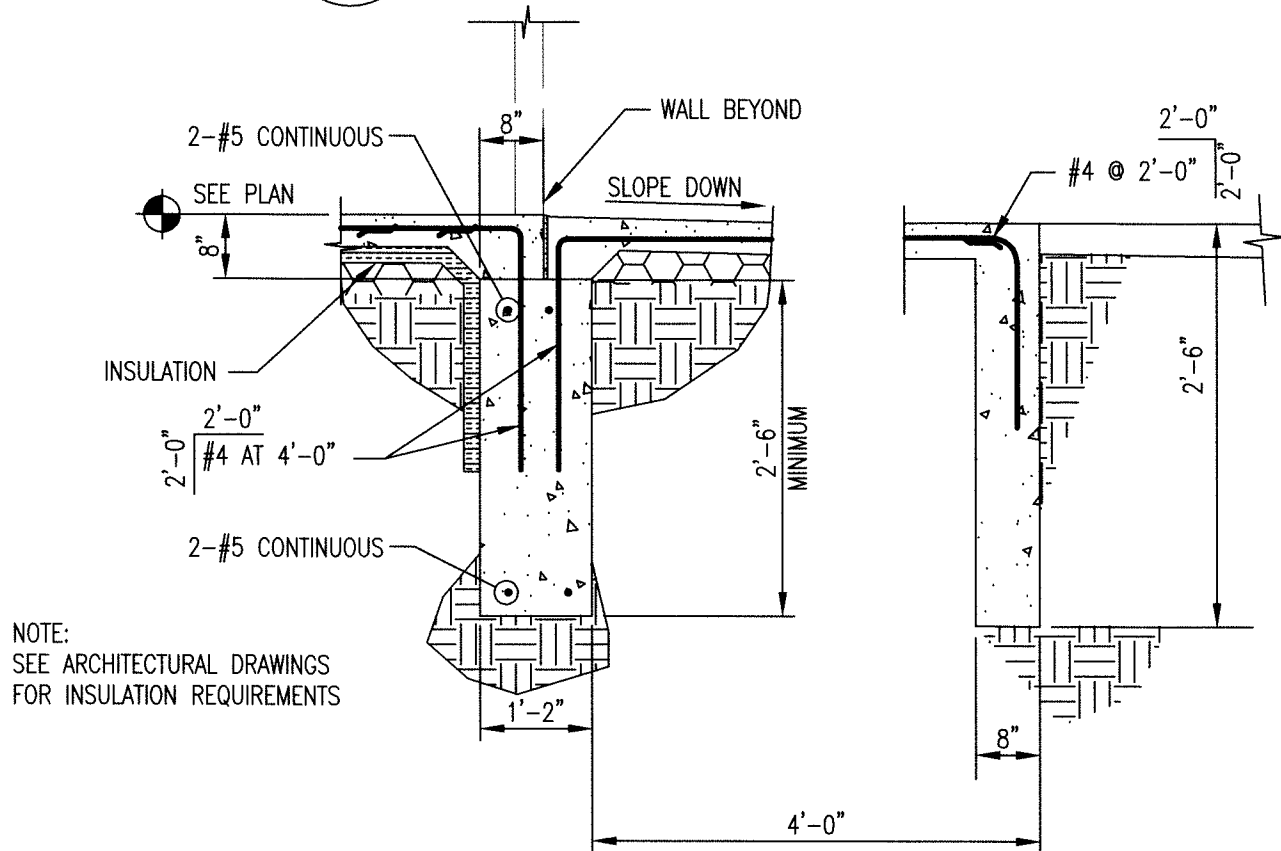


TYP. SECTION  
scale: 1/2"=1'-0"

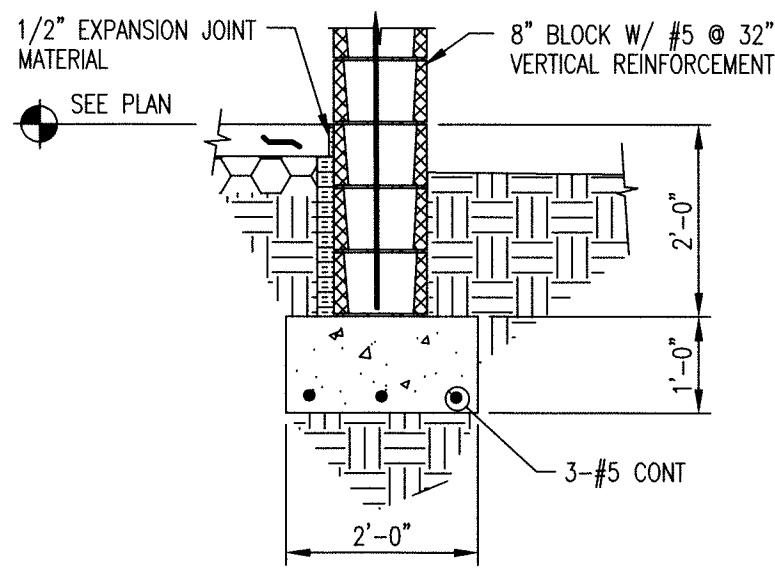

TYPICAL FOUNDATION SUPPORT AT UNSUITABLE SOIL AREAS  
scale: 1/2"=1'-0"

FOR BID PURPOSES ONLY

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www.spaceandsites.com  
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CHECKED	SYMBOL	REVISION	DATE
TN	CERT.	REVISED DETAIL	6/10/19

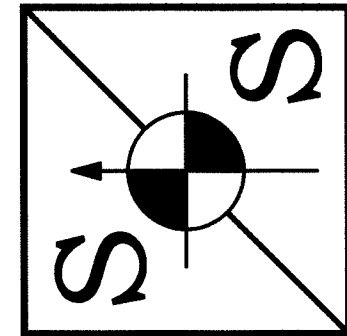SHEET NAME	PROJECT NAME
PROPOSED FOUNDATION DETAILS	SHELBYVILLE PARKS & REC. DEPT. MORRIS AVE. SHELBYVILLE, IN 46176

DATE: May 13, 2019


PROJECT NO.: 18015

SHEET NO.

S101

- GENERAL NOTES:
- ALL CONTRACTORS ARE TO VERIFY ALL DIMENSIONS PER THEIR WORK.
  - ALL CONTRACTORS ARE TO CLEAN UP JOB SITE PER THEIR WORK.
  - ALL CONTRACTORS ARE TO VERIFY ALL APPLICABLE LOCAL CODES OR ORDINANCES PER THEIR WORK.
  - NOTIFY OWNER OF ANY CHANGES REQUIRED PER THESE GENERAL NOTES.
  - OWNER SHALL APPROVE ALL SHOP DRAWINGS REQUIRED OF THIS PROJECT.
  - ALL INTERIOR FINISHES AND MATERIALS SELECTED BY OWNER AND BUILDER.
  - ALL ELECTRICAL AND HVAC LOCATIONS BY OWNER AND BUILDER.
  - ALL TRUSSES AND LAMINATED BEAMS TO BE CERTIFIED BY MANUFACTURER/SUPPLIER.
  - ALL STEEL TO BE CERTIFIED BY MANUFACTURER/SUPPLIER.
  - WINDOW SELECTION BY OWNER AND BUILDER.
  - PROVIDE SINKS, SLOTTEDS AND FINE EXHAUSTERS AS REQUIRED BY STATE AND LOCAL CODES.
  - DOOR SELECTION BY OWNER AND BUILDER (SIZE AND TYPE).



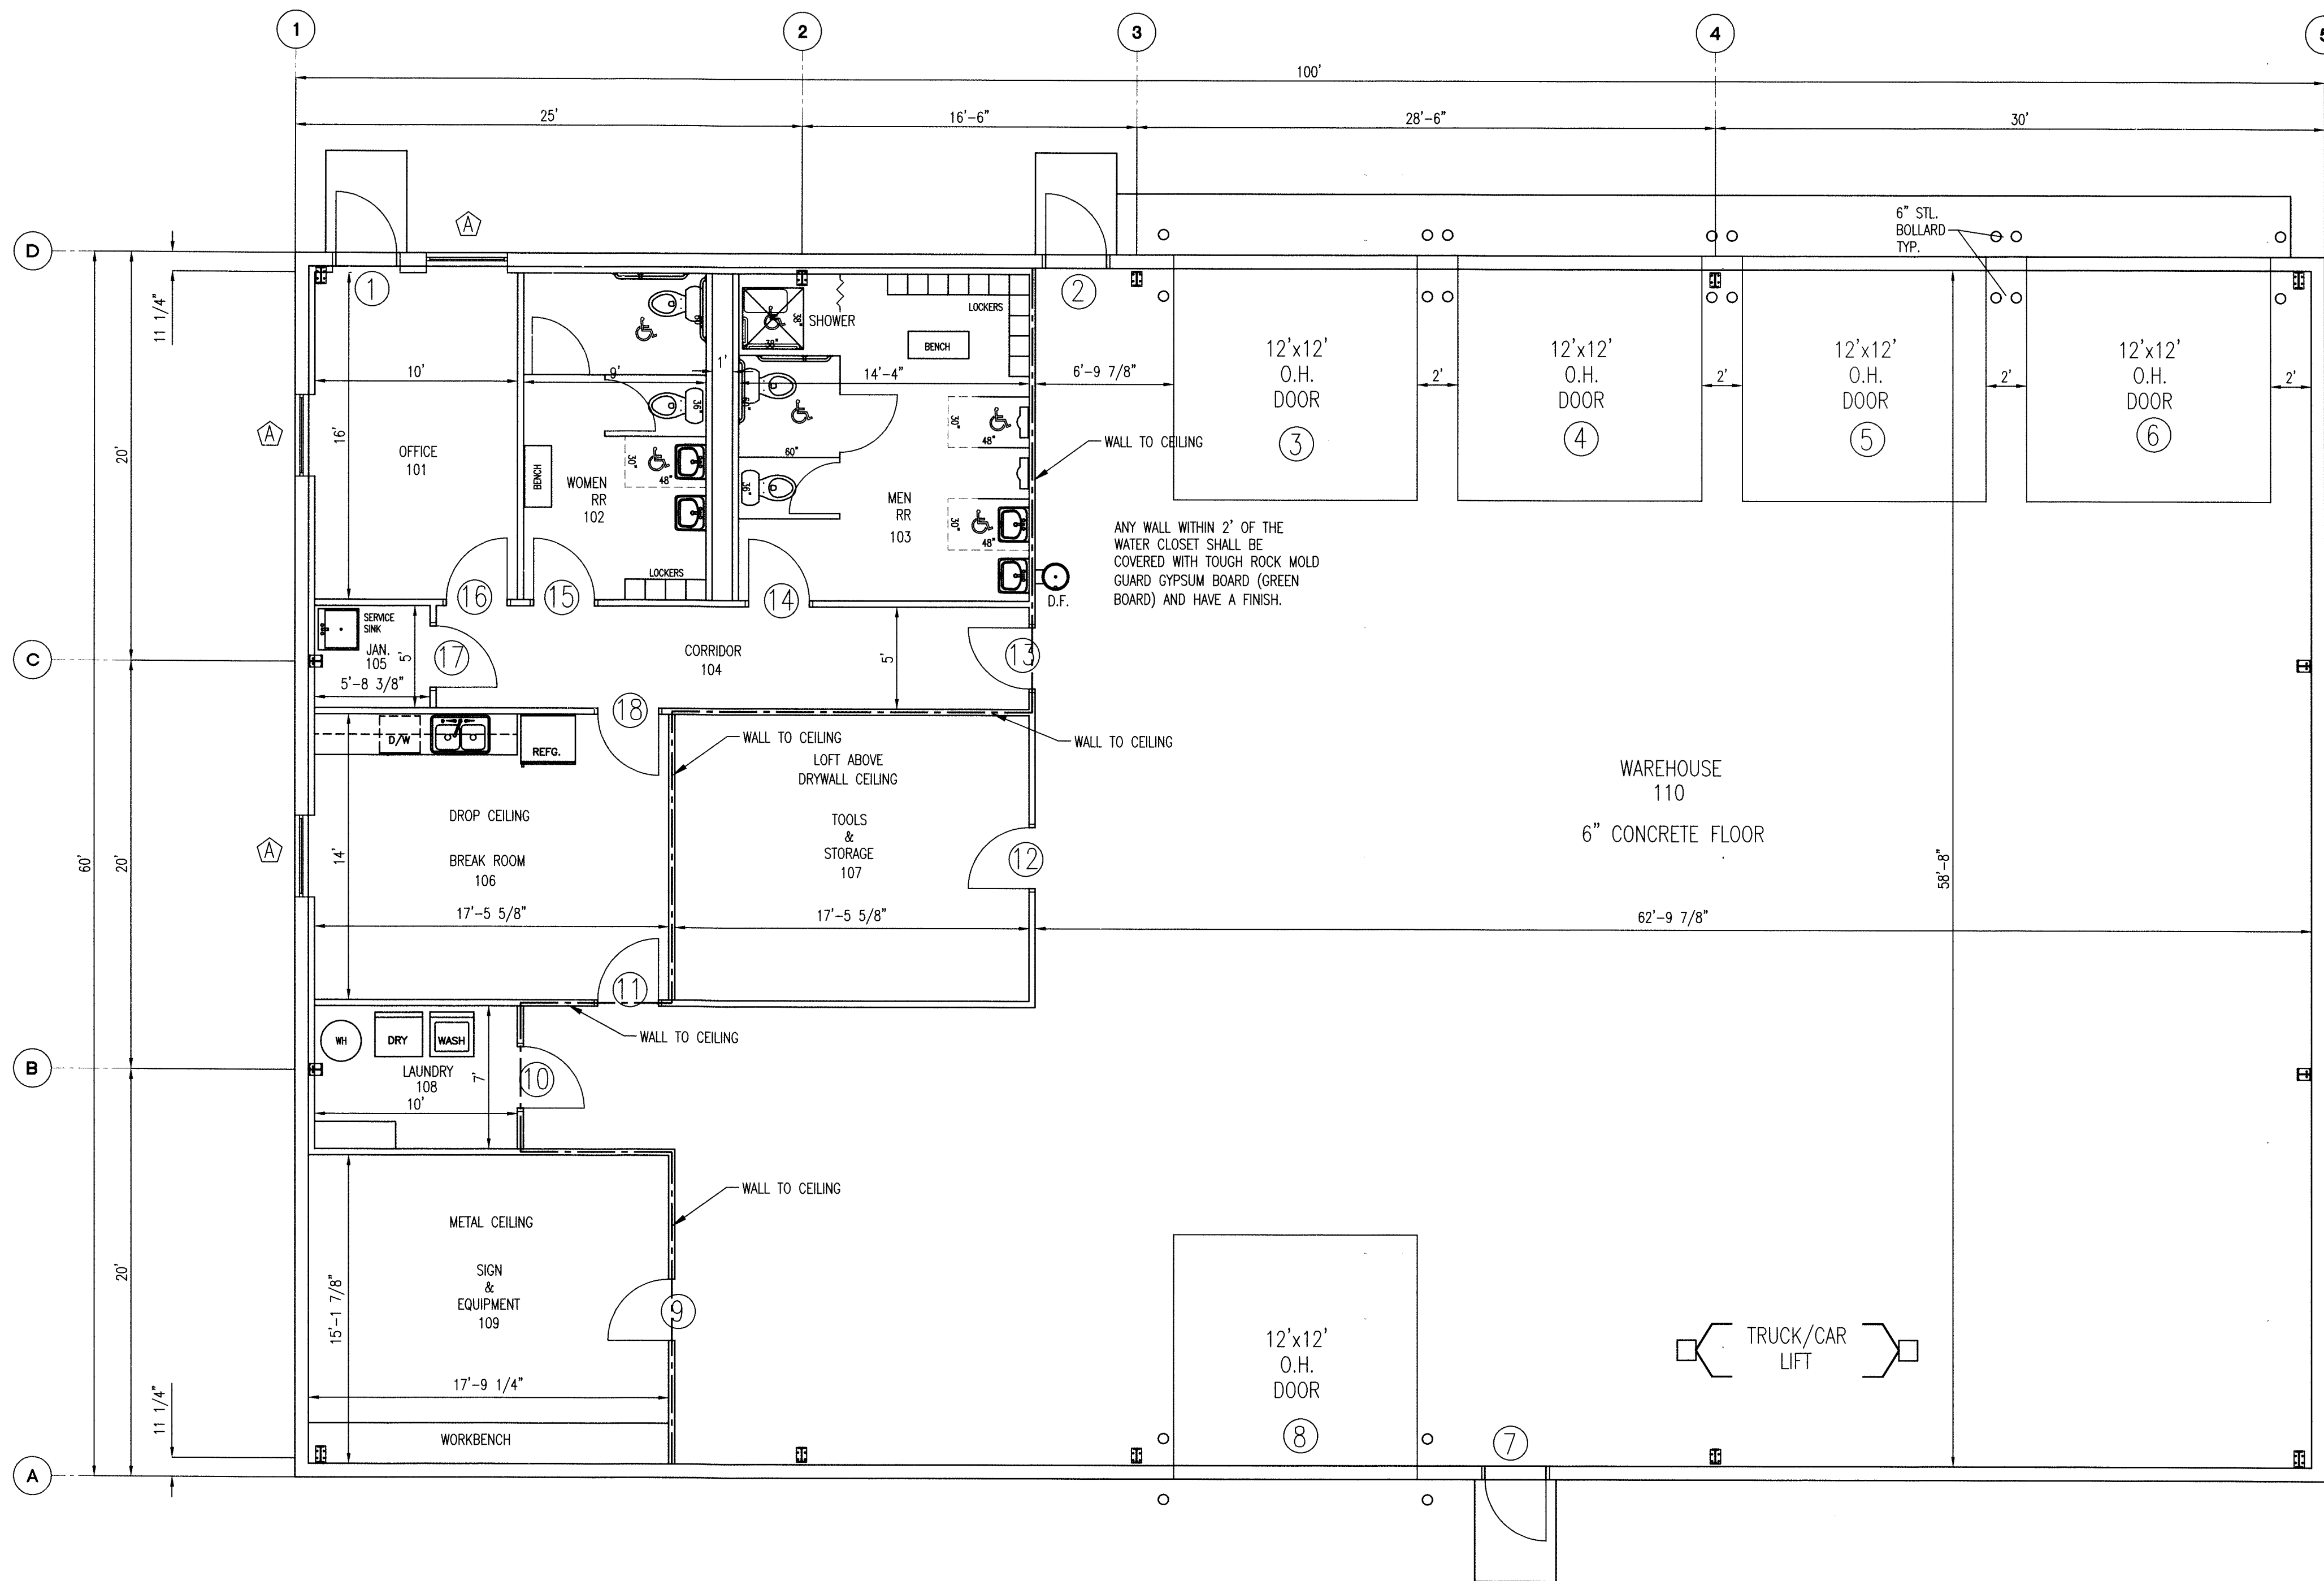


PROPOSED FLOOR PLAN

NOTES:


ALL INTERIOR FRAMING TO BE 3 5/8" METAL STUDS w/ 5/8" TYPE "X" DRYWALL, FINISH AND PAINT. ALSO TO HAVE SOUND BATTS.

ANY WALL WITHIN 2' OF THE WATER CLOSET SHALL BE COVERED WITH TOUGH ROCK MOLD GUARD GYPSUM BOARD (GREEN BOARD) AND HAVE A FINISH.

ALL WORK SHALL BE PREFORMED BY QUALIFIED PERSONNEL PER THEIR TRADE WITH QUALITY WORKMANSHIP AND PER CODES THAT APPLY THAT MAY OR MAY NOT BE SHOWN ON PLANS.

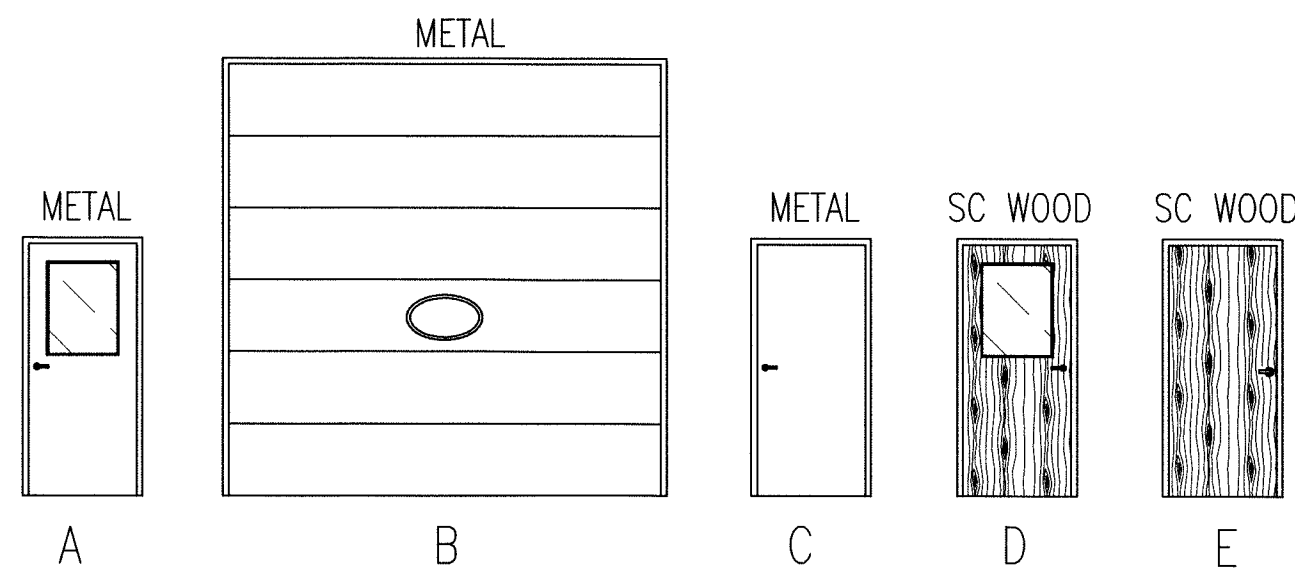

DOOR ELEVATIONS

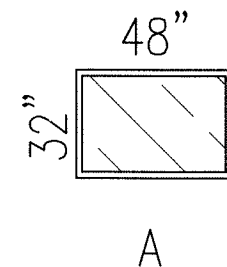

WINDOW ELEVATIONS


ROOM FINISH SCHEDULE					
#	ROOM	WALL	FLOOR	CEILING	Ht.
101	OFFICE	DRYWALL/PAINT	VCT	SUSPENDED	8'
102	WOMEN RR	DRYWALL/FRP	VCT	SUSPENDED	8'
103	MEN RR	DRYWALL/FRP	VCT	SUSPENDED	8'
104	CORRIDOR	DRYWALL/PAINT	VCT	SUSPENDED	8'
105	JANITOR	DRYWALL/PAINT	SEALED CONC.	SUSPENDED	8'
106	BREAK ROOM	DRYWALL/PAINT	VCT	SUSPENDED	8'
107	TOOL/STORAGE	METAL LINER	SEALED CONC.	DRYWALL/PAINT	8'
108	LAUNDRY	DRYWALL/PAINT	SEALED CONC.	SUSPENDED	8'
109	SIGN/EQUIPMENT	METAL LINER	SEALED CONC.	METAL CEILING	8'
110	WAREHOUSE	METAL LINER	SEALED CONC.	LINER	8'

DOOR SCHEDULE					
#	SIZE	TYPE	MATERIAL	REMARKS:	ELEV
1	3'0"x7'0"	ENTRY	METAL	1/2 GLASS	A
2	3'0"x7'0"	ENTRY	METAL	1/2 GLASS	A
3	12'x12'	OVERHEAD	METAL	ELECT. OPENER, WINDOW	B
4	12'x12'	OVERHEAD	METAL	ELECT. OPENER, WINDOW	B
5	12'x12'	OVERHEAD	METAL	ELECT. OPENER, WINDOW	B
6	12'x12'	OVERHEAD	METAL	ELECT. OPENER, WINDOW	B
7	3'0"x7'0"	ENTRY	METAL	1/2 GLASS	A
8	12'x12'	OVERHEAD	METAL	NO WINDOW	B
9	3'0"x7'0"	PASSAGE	METAL		C
10	3'0"x7'0"	PASSAGE	METAL		C
11	3'0"x7'0"	PASSAGE	SC WOOD	1/2 GLASS	D
12	3'0"x7'0"	PASSAGE	METAL		C
13	3'0"x7'0"	PASSAGE	METAL	1/2 GLASS	A
14	3'0"x7'0"	PASSAGE	SC WOOD		E
15	3'0"x7'0"	PASSAGE	SC WOOD		E
16	3'0"x7'0"	PASSAGE	SC WOOD		E
17	3'0"x7'0"	PASSAGE	METAL		C
18	3'0"x7'0"	PASSAGE	SC WOOD	1/2 GLASS	D


ALL DOORS TO HAVE METAL FRAMES.  
VERIFY HARDWARE, LOCKS, ETC. WITH OWNER.

WINDOW SCHEDULE					
#	SIZE	TYPE	MATERIAL	REMARKS:	QTY.
A	48"x32"	FIXED	ALUMN./GLASS	-	3

- GENERAL NOTES:
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  2. ALL CONTRACTORS ARE TO CLEAN UP JOB SITE PER THEIR WORK.
  3. ALL CONTRACTORS ARE TO VERIFY ALL APPLICABLE LOCAL CODES OR ORDINANCES PER THEIR WORK.
  4. NOTIFY OWNER OF ANY CHANGES REQUIRED PER THESE GENERAL NOTES.
  5. OWNER SHALL APPROVE ALL SHOP DRAWINGS REQUIRED OF THIS PROJECT.
  6. ALL INTERIOR FINISHES AND MATERIALS SELECTED BY OWNER AND BUILDER.
  7. ALL ELECTRICAL AND HVAC LOCATIONS BY OWNER AND BUILDER.
  8. ALL TRUSSES AND LAMINATED BEAMS TO BE CERTIFIED BY MANUFACTURER/SUPPLIER.
  9. ALL STEEL TO BE CERTIFIED BY MANUFACTURER/SUPPLIER.
  10. WINDOW SELECTION BY OWNER AND BUILDER.
  11. PROVIDE SMOKE DETECTORS AND FIRE EXTINGUISHERS AS REQUIRED BY STATE AND LOCAL CODES.
  12. DOOR SELECTION BY OWNER AND BUILDER (SIZE AND TYPE).

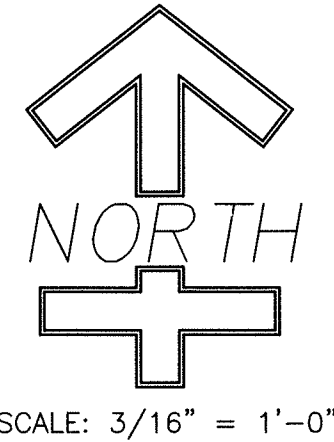

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CHECKED	SYMBOL	REVISION	DATE
IN		REVISED-O.H. DOOR SIZE. WALL TO CEILING	4/17/19
CERT.			
SCALE			
5/16"=1'			
DRAWN			
RC			

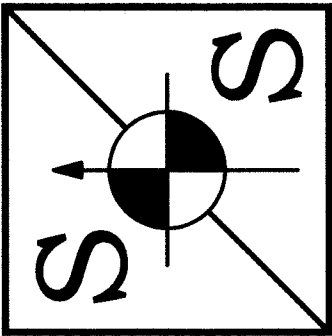FOR BID PURPOSES ONLY





SHEET NAME  
PROPOSED FLOOR PLAN  
PROJECT NAME  
SHELBYVILLE PARKS & REC. DEPT.  
MAINTENANCE BUILDING, BLUE RIVER PARK  
1021 MORRIS AVE., SHELBYVILLE, IN 46176

DATE: MAY 13, 2019


PROJECT NO.: 18015

SHEET NO.

A100

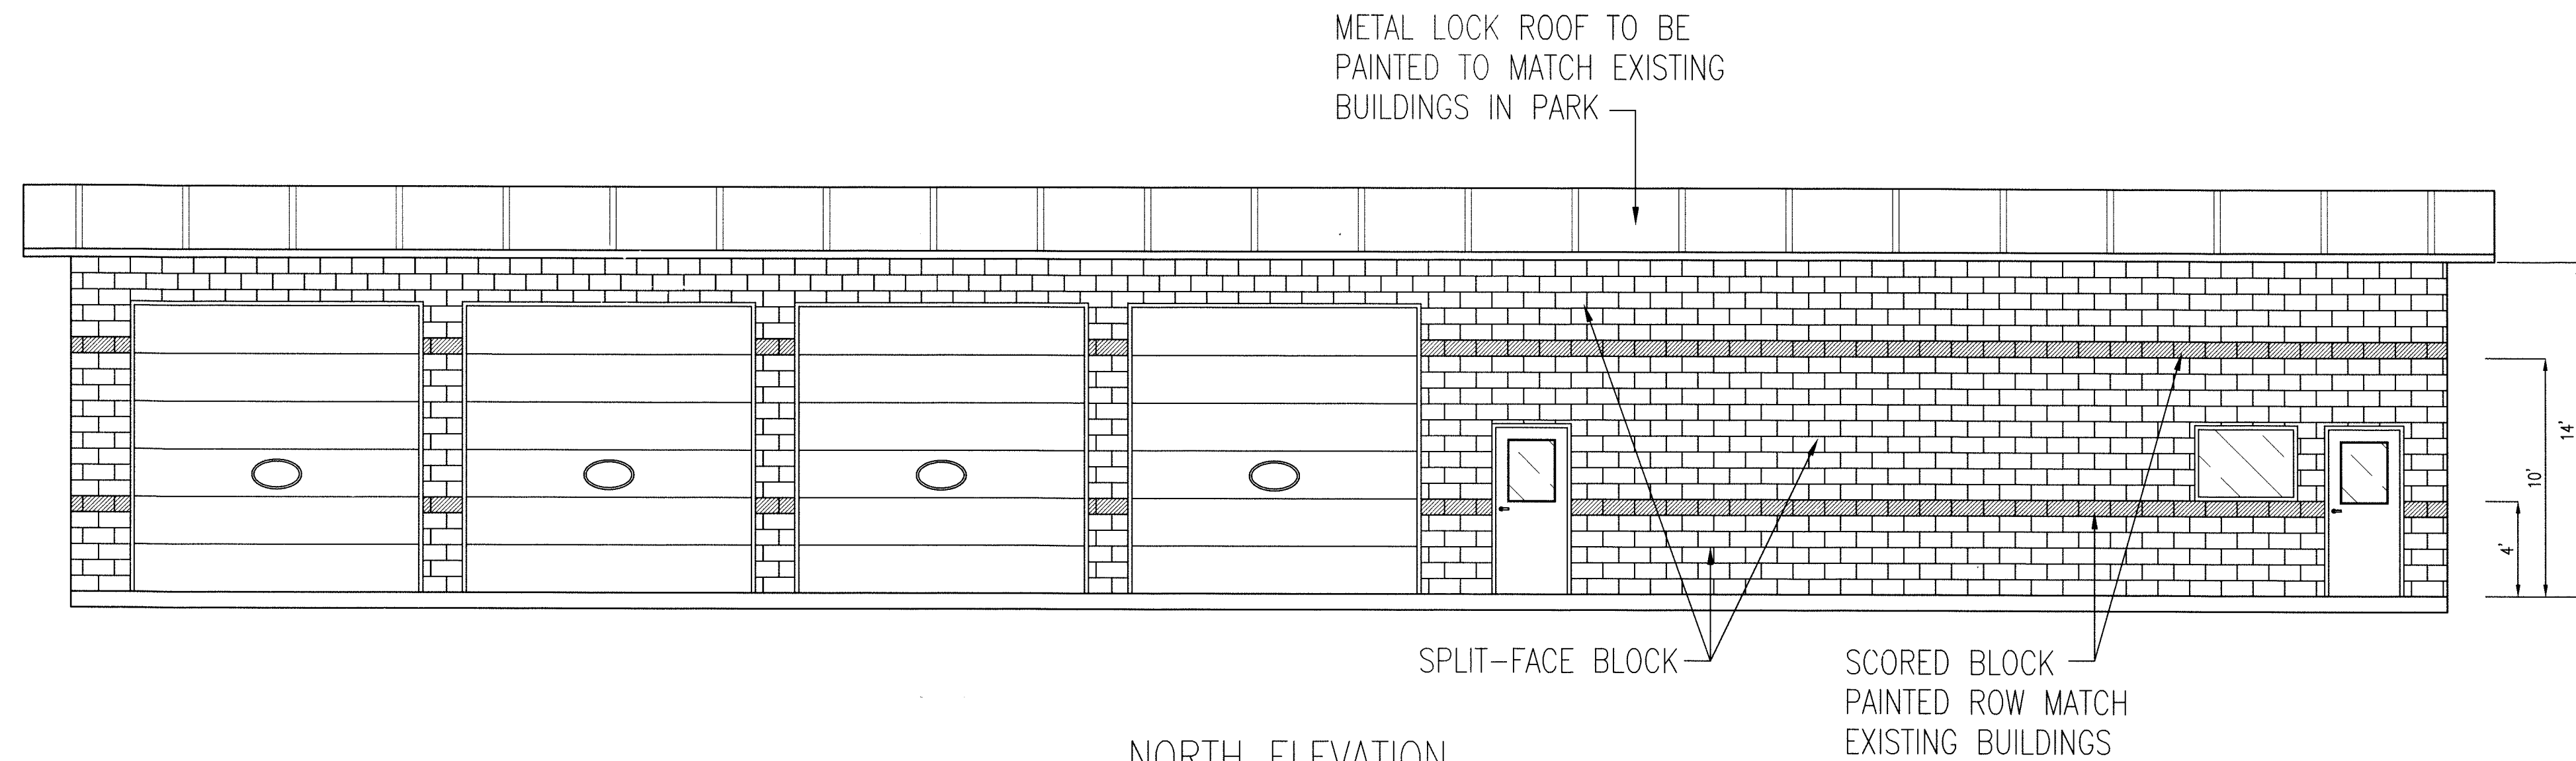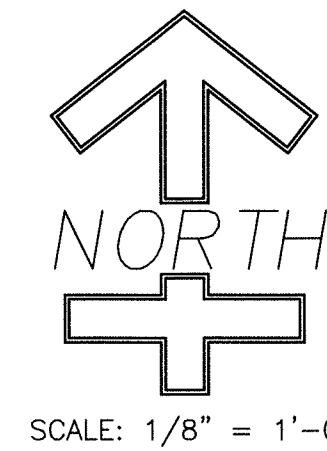


NORTH ELEVATION

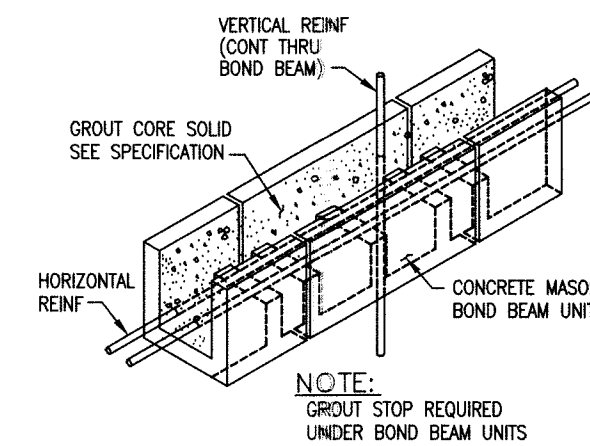


1 TYPICAL BOND BEAM  
A200

G.C. TO VERIFY STEEL BUILDINGS MANUFACTURING ROOF DESIGN  
WILL ALLOW 3 PSF FOR SOLAR PANEL INSTALLATION BY OTHERS.

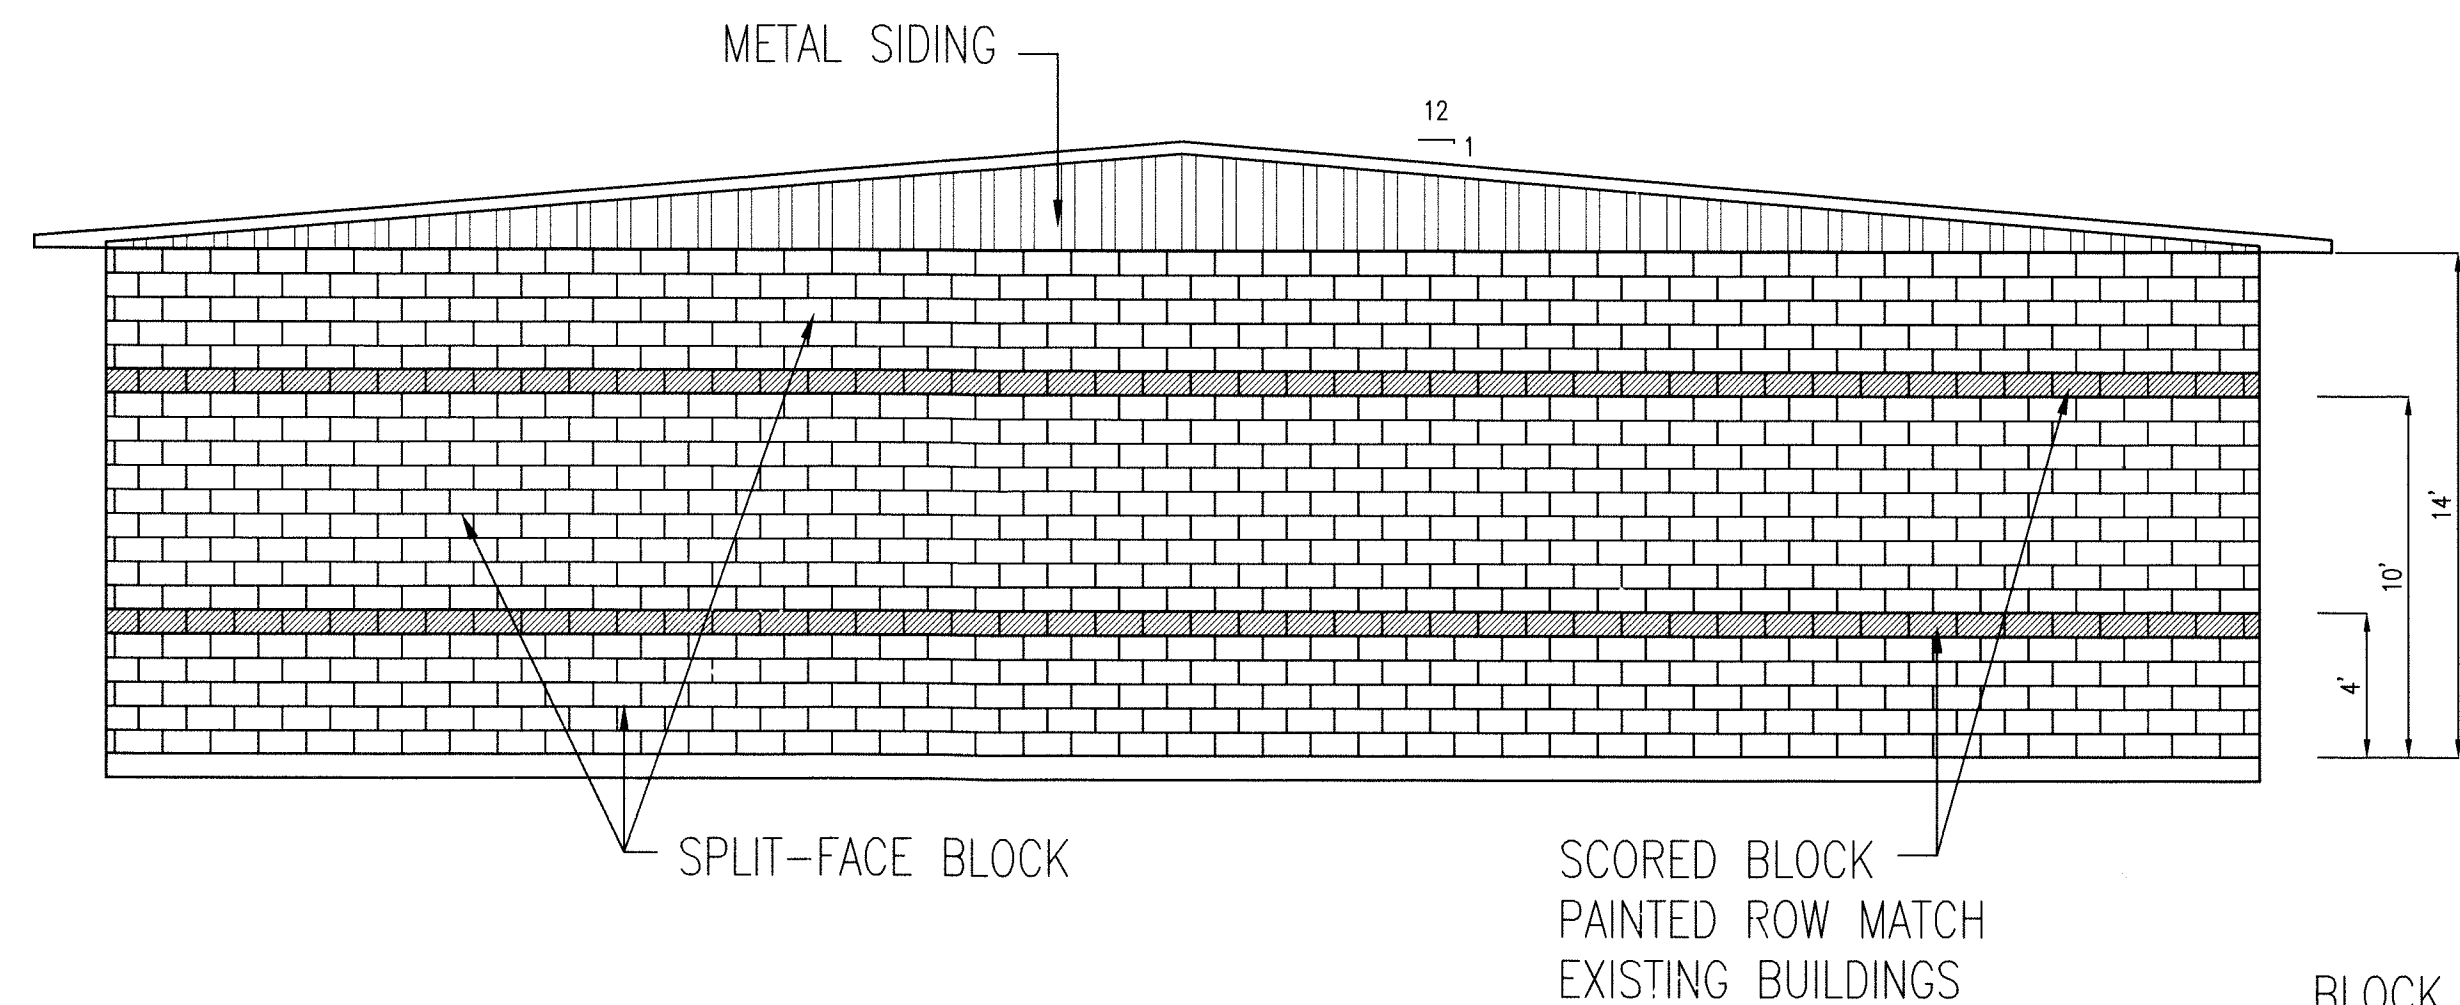


EAST ELEVATION

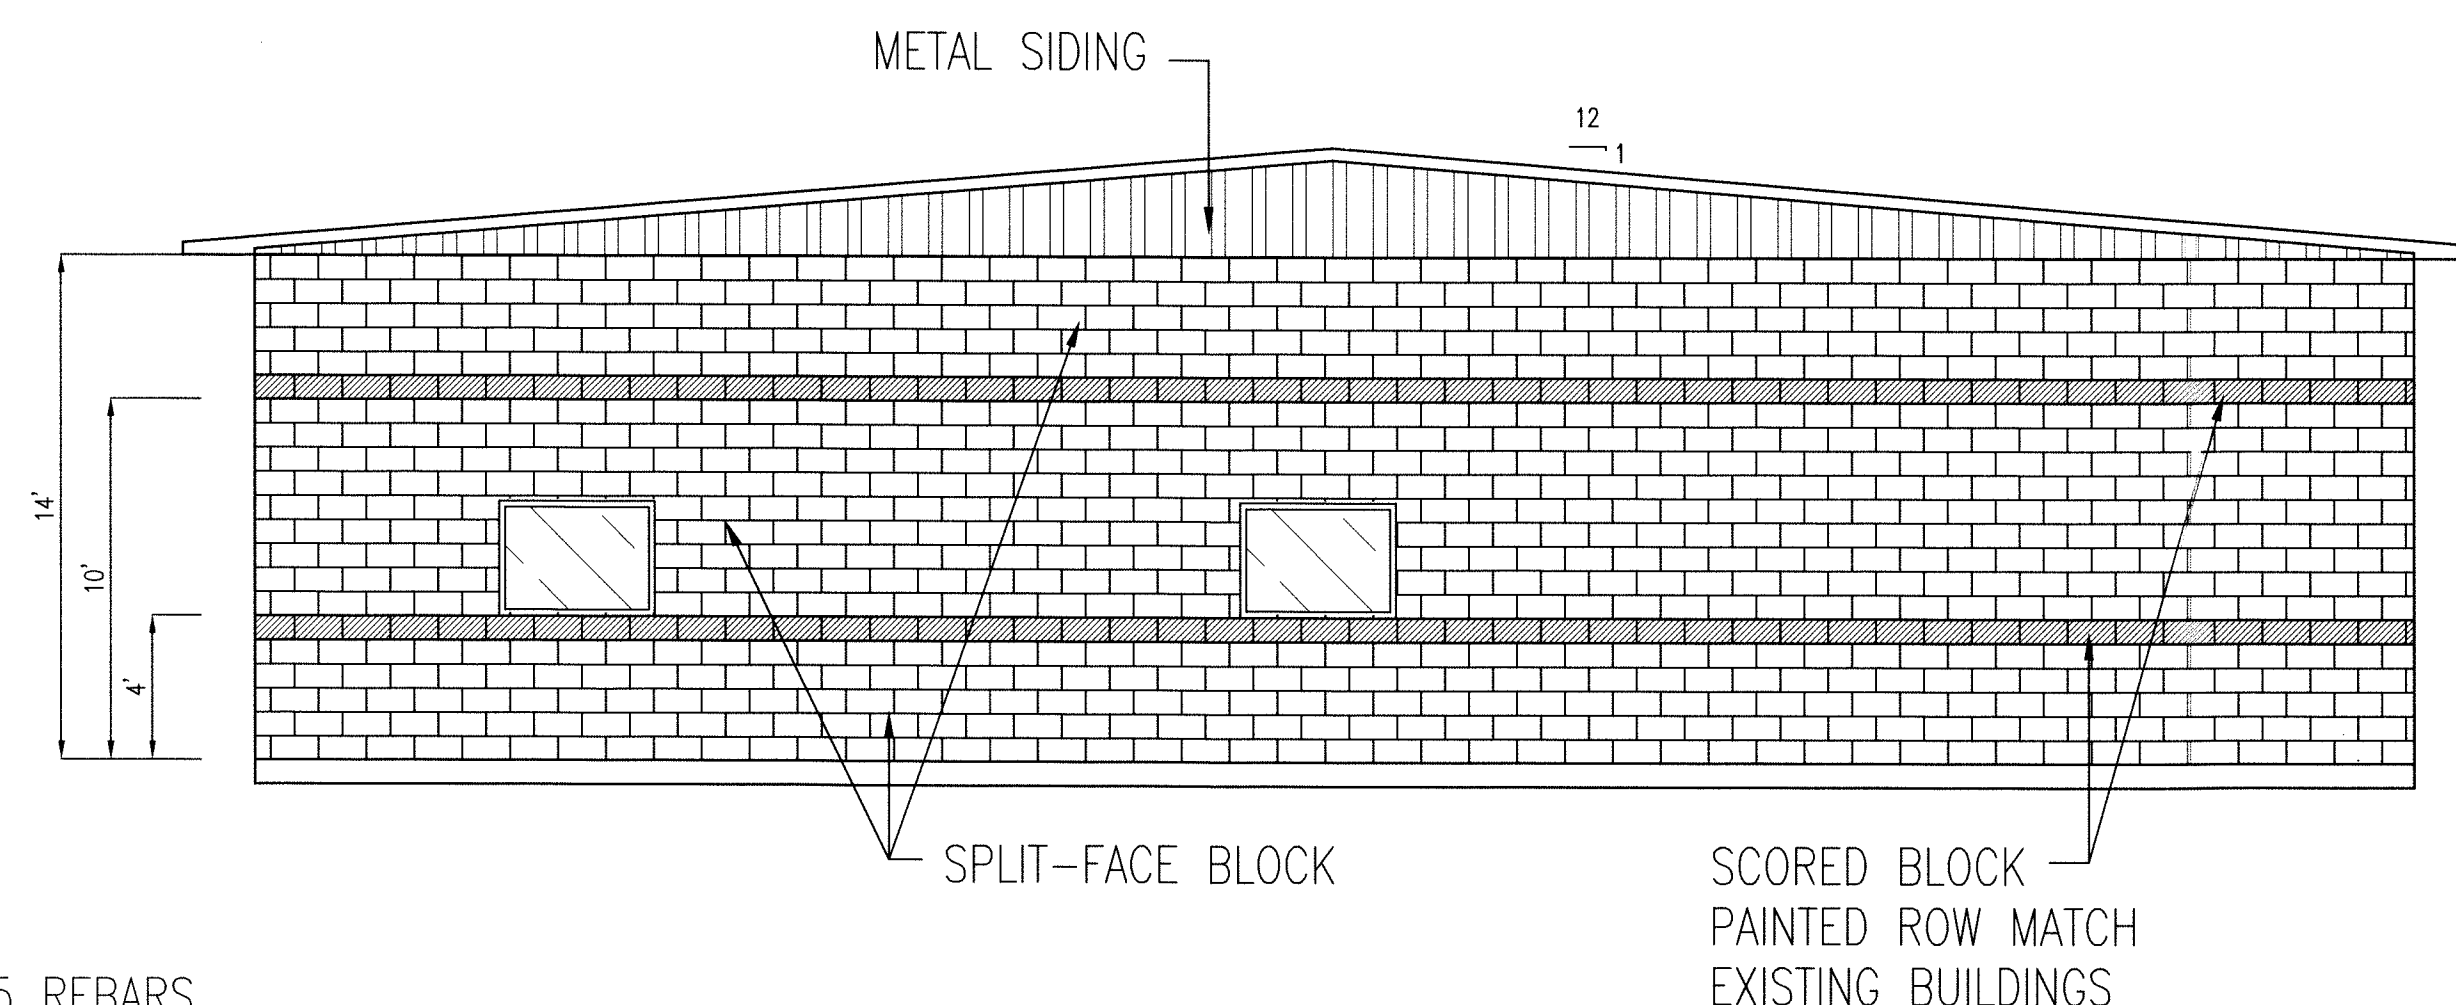

WEST ELEVATION

BLOCK WALLS TO HAVE #5 REBARS  
32" O.C. w/DURAWALL @ 16" O.C.,  
(2) BOND BEAMS, ABOVE WINDOWS  
AND TOP COURSE, FOAM CORES,  
SEAL AND PAINT BLOCK

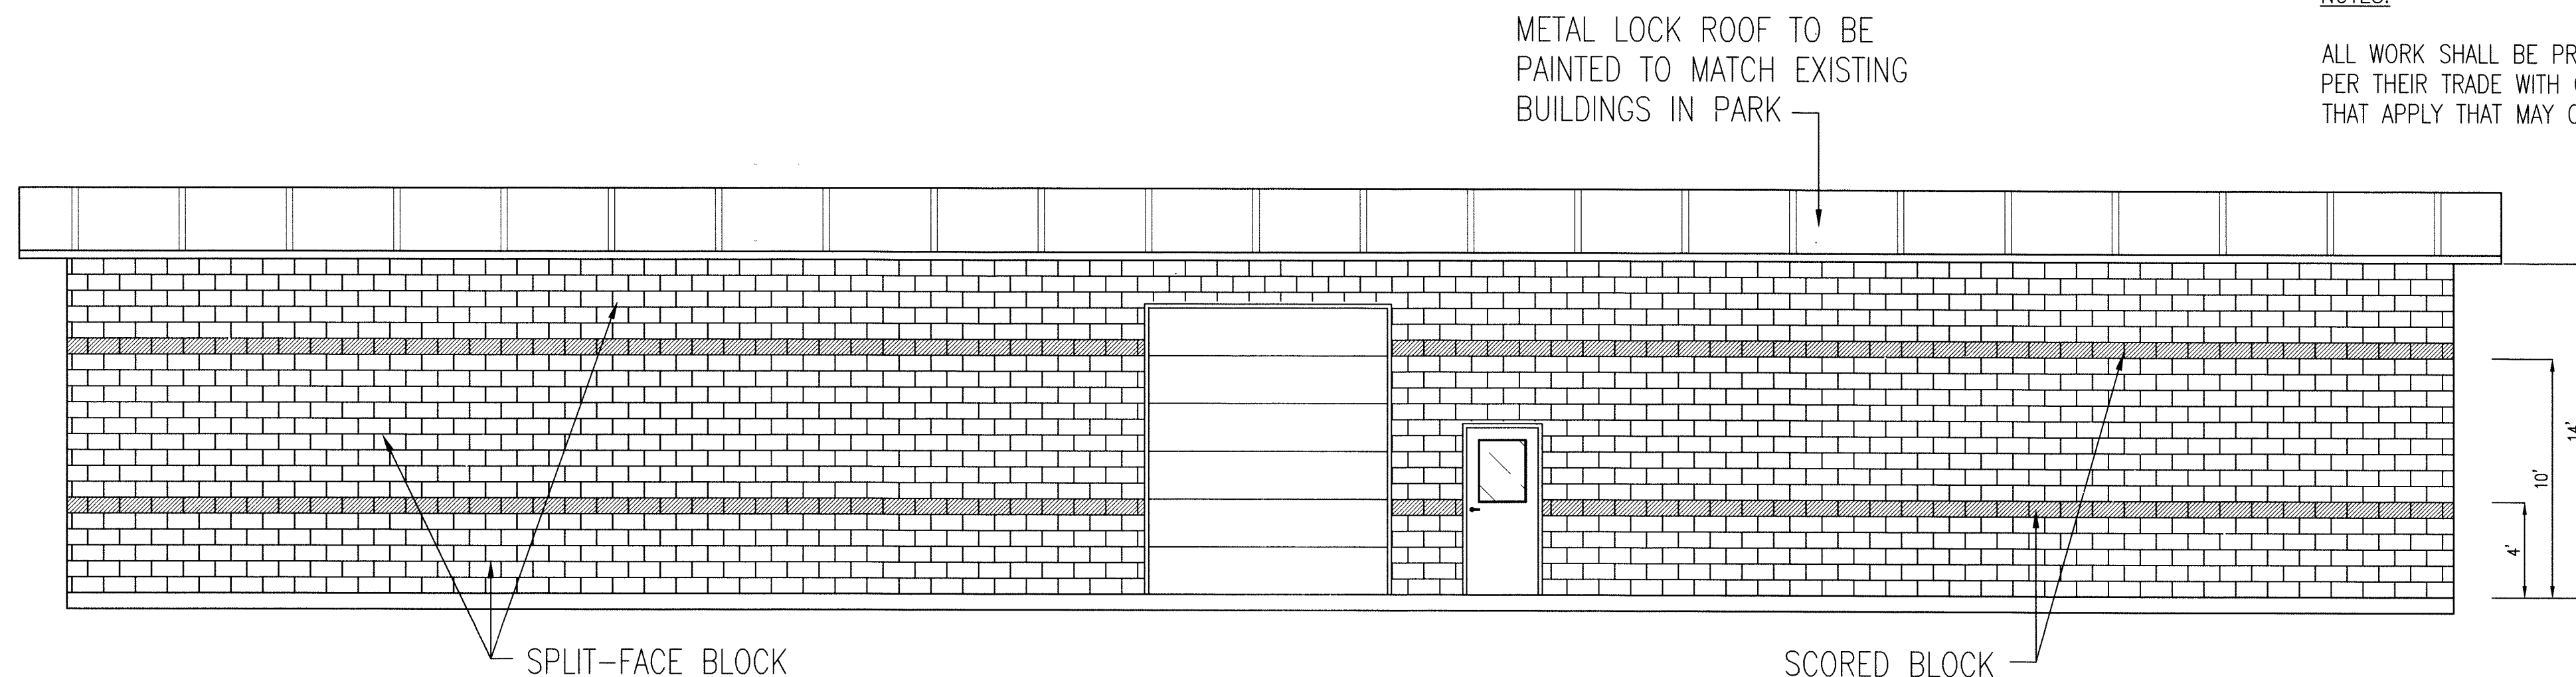

SOUTH ELEVATION

NOTES:


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PER THEIR TRADE WITH QUALITY WORKMANSHIP AND PER CODES  
THAT APPLY THAT MAY OR MAY NOT BE SHOWN ON PLANS.



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  3. ALL CONTRACTORS ARE TO OBTAIN ALL NECESSARY LOCAL, STATE, AND FEDERAL PERMITS AND ORDINANCES PER THEIR WORK.
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CHECKED	SYMBOL	REVISION	DATE
TN		REVISED NOTES	6/10/19
CERT.			
SCALE			
5/16"=1'			
DRAWN			
RC			

SHEET NAME	PROJECT NAME
PROPOSED EXTERIOR ELEVATIONS	SHELBYVILLE PARKS & REC. DEPT. MAINTENANCE BUILDING, BLUE RIVER PARK 1021 MORRIS AVE., SHELBYVILLE, IN 46176


DATE: MAY 13, 2019

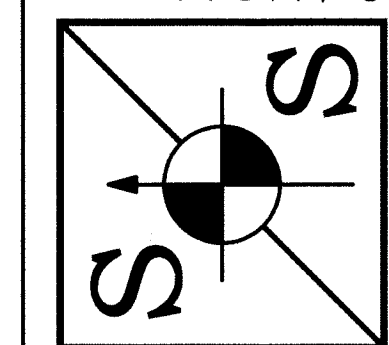PROJECT NO.: 18015

SHEET NO.


A200



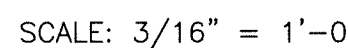

SEAL

DATE: MAY 13, 2019
PROJECT NO.: 18015
SHEET NO.
M100

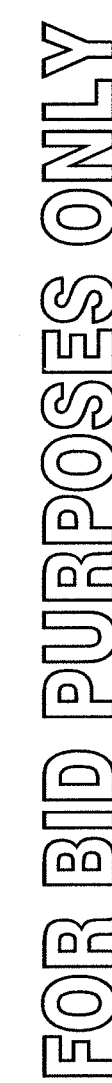


## PROPOSED MECHANICAL PLAN


— GAS — 1" GAS LINE

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3. ALL CONTRACTORS ARE TO VERIFY ALL APPLICABLE LOCAL CODES OR ORDINANCES PER THEIR WORK.
4. NOTIFY OWNER OF ANY CORRECTIONS REQUIRED PER THE GENERAL NOTES.
5. CONTRACTORS SHALL APPROVE ALL SHOP DRAWINGS AND REPORTS OF THIS PROJECT.
6. ALL INTERIOR FINISHES AND MATERIALS SELECTED BY OWNER AND BUILDER.
7. ELECTRICAL AND HVAC LOCATIONS TO BE DETERMINED BY OWNER AND BUILDER.
8. ALL TRUSSES AND LAMINATED BEAMS TO BE CERTIFIED BY MANUFACTURER/SUPPLIER.
9. ALL STEEL TO BE CERTIFIED BY MANUFACTURER/SUPPLIER.
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12. DOOR SELECTION BY OWNER AND BUILDER (SIZE AND TYPE).

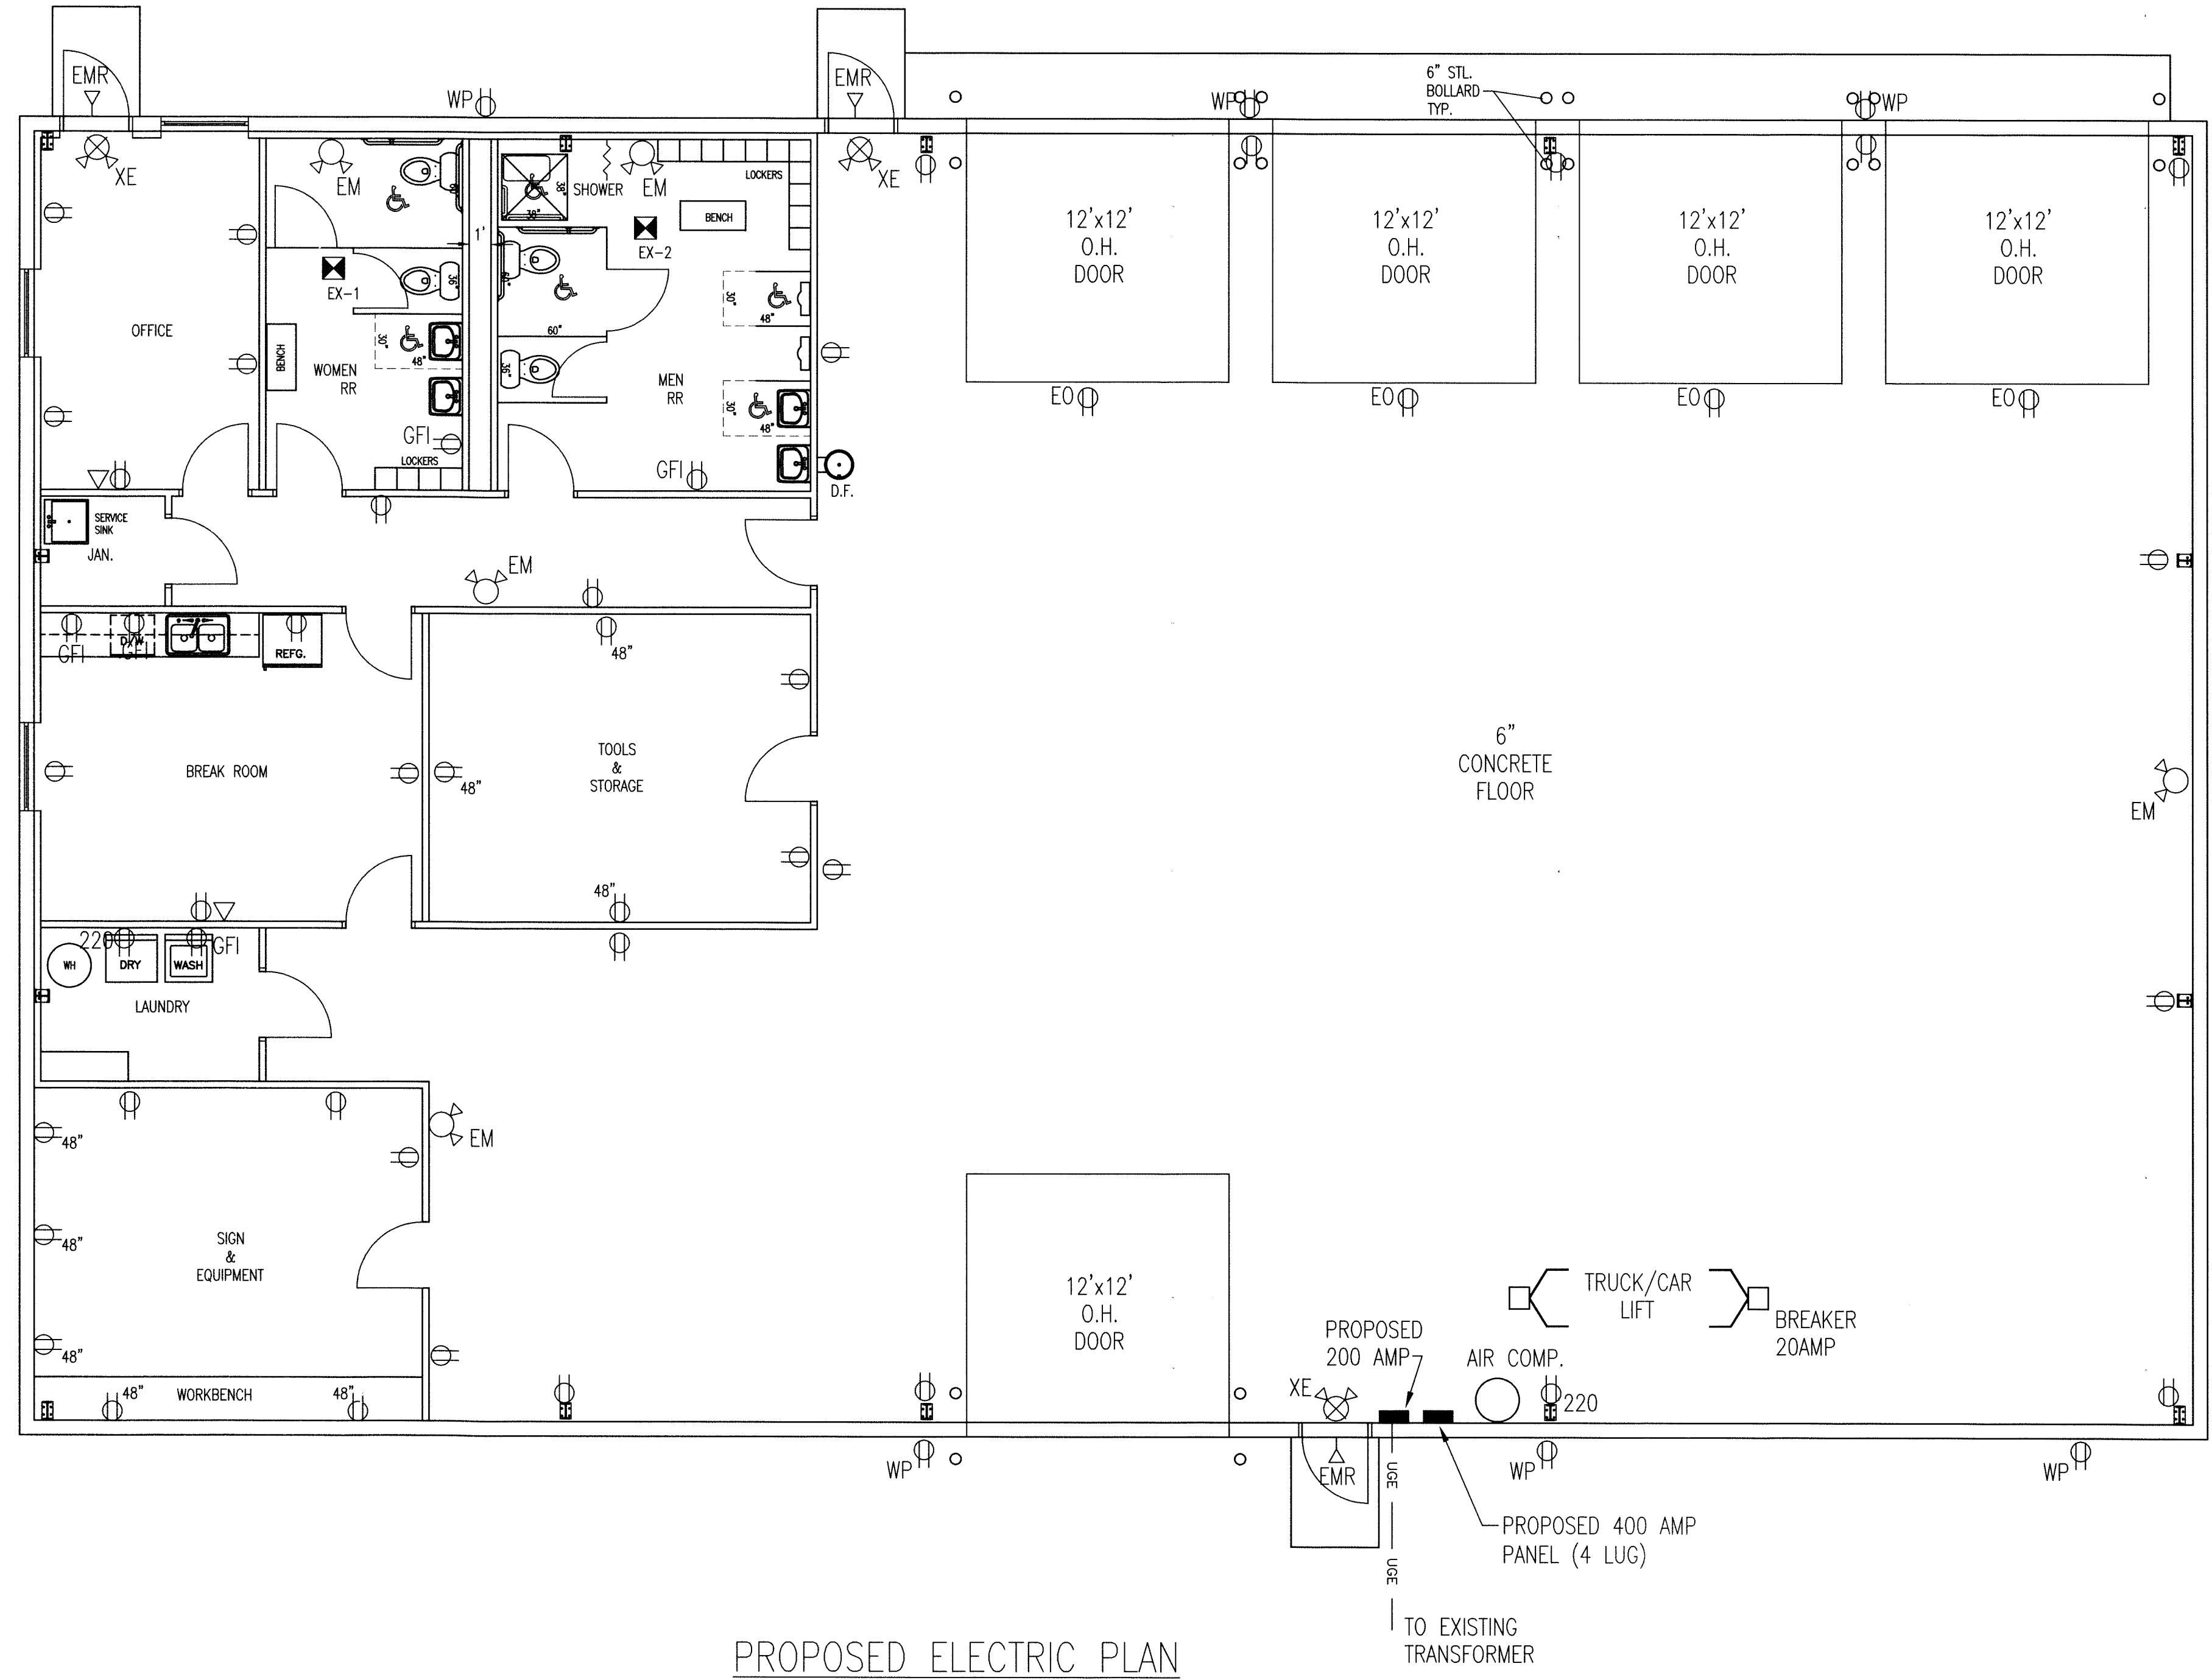

PROPOSED ELECTRIC PLAN

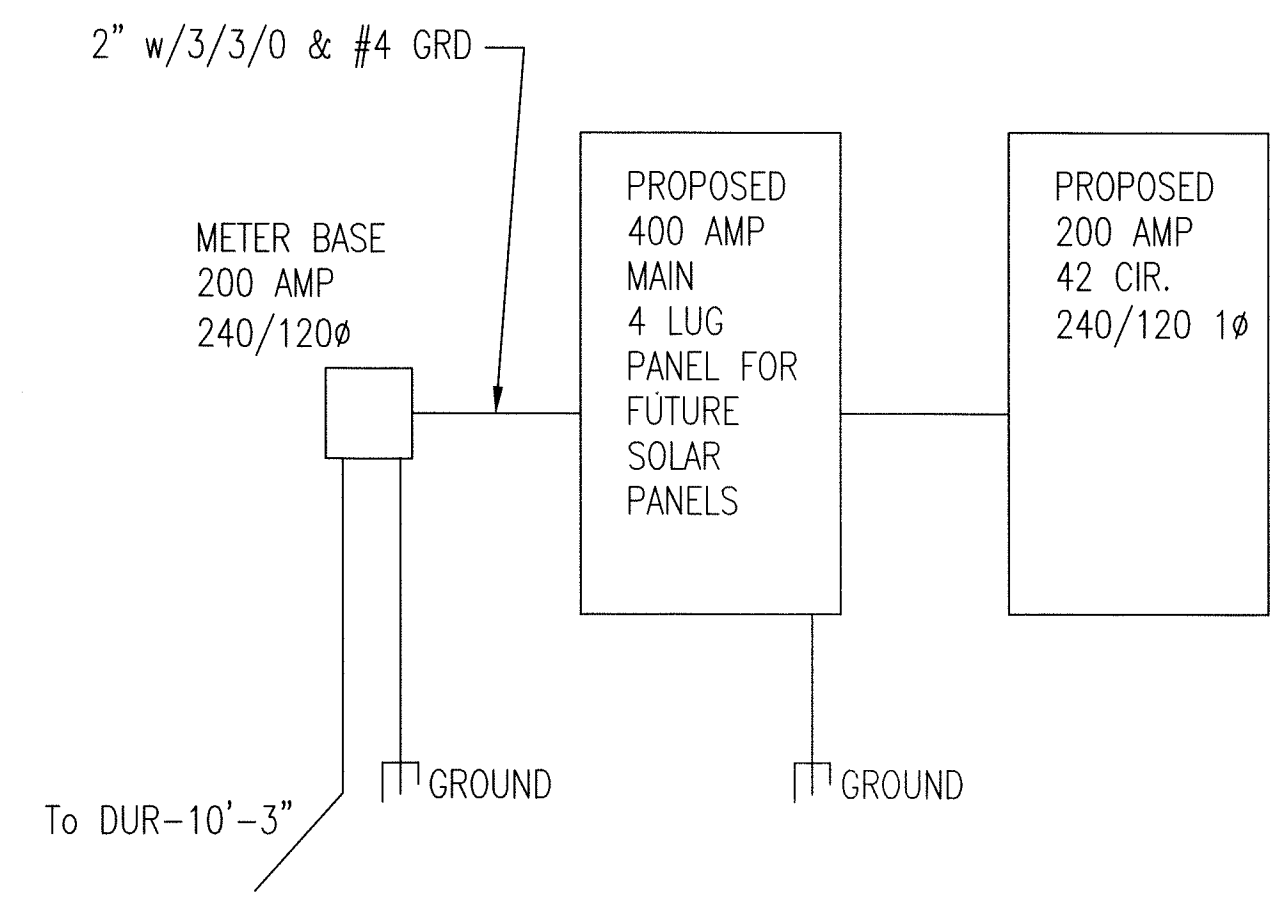

RISER DIAGRAM

- LEGEND**
- § SINGLE POLE SWITCH
  - §<sup>3</sup> 3-WAY SWITCH
  - ⊕ DUPLEX RECEPTACLE
  - GFI ⊕ GROUND FAULT INTERCEPTION
  - WP ⊕ WEATHERPROOF GFI RECEPTACLE
  - EO ⊕ OVERHEAD DOOR RECEPTACLE
  - △ DATA OPENINGS ONLY (WIRES, PLATES, JACKS BY OTHERS)
  - A COLUMBIA- CFP24-5540 FLAT PANEL LED
  - B ILP HHB 135W LED UNV 50FRL HIGH BAY FIXTURES
  - XE ⊕ EXIT LIGHT W/BATTERY BACK UP W/EMERGENCY HEADS AND REMOTE CAPABILITY
  - EMR ⊕ SINGLE WEATHERPROOF REMOTE HEAD POWERED BY EXIT EMERGENCY
  - EM ⊕ EMERGENCY LIGHT W/BATTERY BACK UP
  - L1 WALL PAK ⊕ ILP WPCM 75W LED UNV 40K WALL PACKS
  - EX-# ⊕ EXHAUST FAN-RESTROOM-75 CFM VENT TO OUTSIDE

**NOTES:**


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- GENERAL ELECTRICAL NOTES:**
1. ALL MATERIAL AND WORKMANSHIP SHALL COMPLY WITH ALL APPLICABLE CODES, SPECIFICATIONS, LOCAL ORDINANCES AND INDUSTRY STANDARDS.
  2. NATIONAL ELECTRICAL CODE (NEC) AND INDUSTRY INSTALLATION STANDARDS SHALL BE CONSIDERED MINIMUM STANDARDS.
  3. ALL CONDUIT AND BOXES SHALL BE PROPERLY SUPPORTED.
  4. ALL GRS OR IMC CONDUITS ENTERING BOXES OR ENCLOSURES WITHOUT HUBS SHALL BE EQUIPPED WITH BUSHINGS AND SHALL HAVE LOCKOUTS INSIDE AND OUT OF ENCLOSURE.
  5. ALL NECESSARY HANGERS AND/OR MOUNTING ACCESSORIES FOR LIGHTING FIXTURES SHALL BE PROVIDED BY E.C.
  6. VERIFY ALL DIMENSIONS FROM ARCHITECTURAL PLANS.
  7. DIMENSIONS SHOWN ON OUTLET BOXES SHALL BE FROM THE FINISHED FLOOR TO THE CENTER OF THE BOX.
  8. COORDINATE LOCATION OF LIGHTS IN ROOMS CONTAINING EXPOSED DUCTWORK AND PIPING BY OTHER TRADES.
  9. VERIFY ELECTRICAL CHARACTERISTICS AND ROUGH-IN REQUIREMENTS FOR ALL EQUIPMENT FURNISHED BY OTHERS AND CONNECTED BY E.C.
  10. COORDINATE LOCATION OF MOTOR STARTERS, DISCONNECTS, PANELBOARDS, ETC. IN ROOMS CONTAINING EXPOSED DUCTWORK AND PIPING BY OTHER TRADES.
  11. VERIFY HEIGHT AND LOCATION OF OUTLETS BEHIND WATER COOLERS WITH OTHER TRADES, SO THAT OUTLETS ARE CONCEALED.
  12. REFER TO ARCHITECTURAL PLANS FOR DETAILS AND NOTES CONCERNING ITEMS INVOLVING ELECTRICAL WORK.
  13. REFER TO ARCHITECTURAL REFLECTED CEILING PLAN FOR CEILING TYPES AND FIXTURE LOCATIONS. ANY CONFLICTS BETWEEN ELECTRICAL PLANS AND REFLECTED CEILING PLANS SHALL BE REPORTED AND RESOLVED PRIOR TO ROUGH-IN.
  14. REFER TO ARCHITECTURAL PLANS FOR FINAL DOOR SWING AND LIGHT SWITCH LOCATIONS. ANY CONFLICT BETWEEN ELECTRICAL PLANS AND ARCHITECTURAL PLANS SHALL BE REPORTED AND RESOLVED PRIOR TO ROUGH-IN.
  15. REFER TO ARCHITECTURAL PLANS FOR ELEVATIONS OF CASEWORK AND/OR BUILT-IN SHELVING UNITS TO COORDINATE OUTLET ELEVATIONS. ANY CONFLICT BETWEEN ELECTRICAL PLANS AND ARCHITECTURAL PLANS SHALL BE REPORTED AND RESOLVED PRIOR TO ROUGH-IN.
  16. ALL FEEDERS AND BRANCH CIRCUITS RAN UNDERGROUND IN PVC CONDUIT SHALL INCLUDE A GROUND CONDUCTOR.
  17. ALL DISCONNECT SWITCHES LOCATED OUTDOORS SHALL BE NEMA 3R (UNO)
  18. ALL DISCONNECT SWITCHES LOCATED INDOORS SHALL BE NEMA 1, U.N.O.
  19. ALL DISCONNECT SWITCHES LOCATED IN CORROSIVE ATMOSPHERES SHALL BE NEMA 4X (U.N.O.).
  20. ANY 110V CIRCUITS OVER 120FT USE #10 WIRE.
  21. ALL WIRING IN EMT (EXPLODED) AND MC CABLE CONCEALED.

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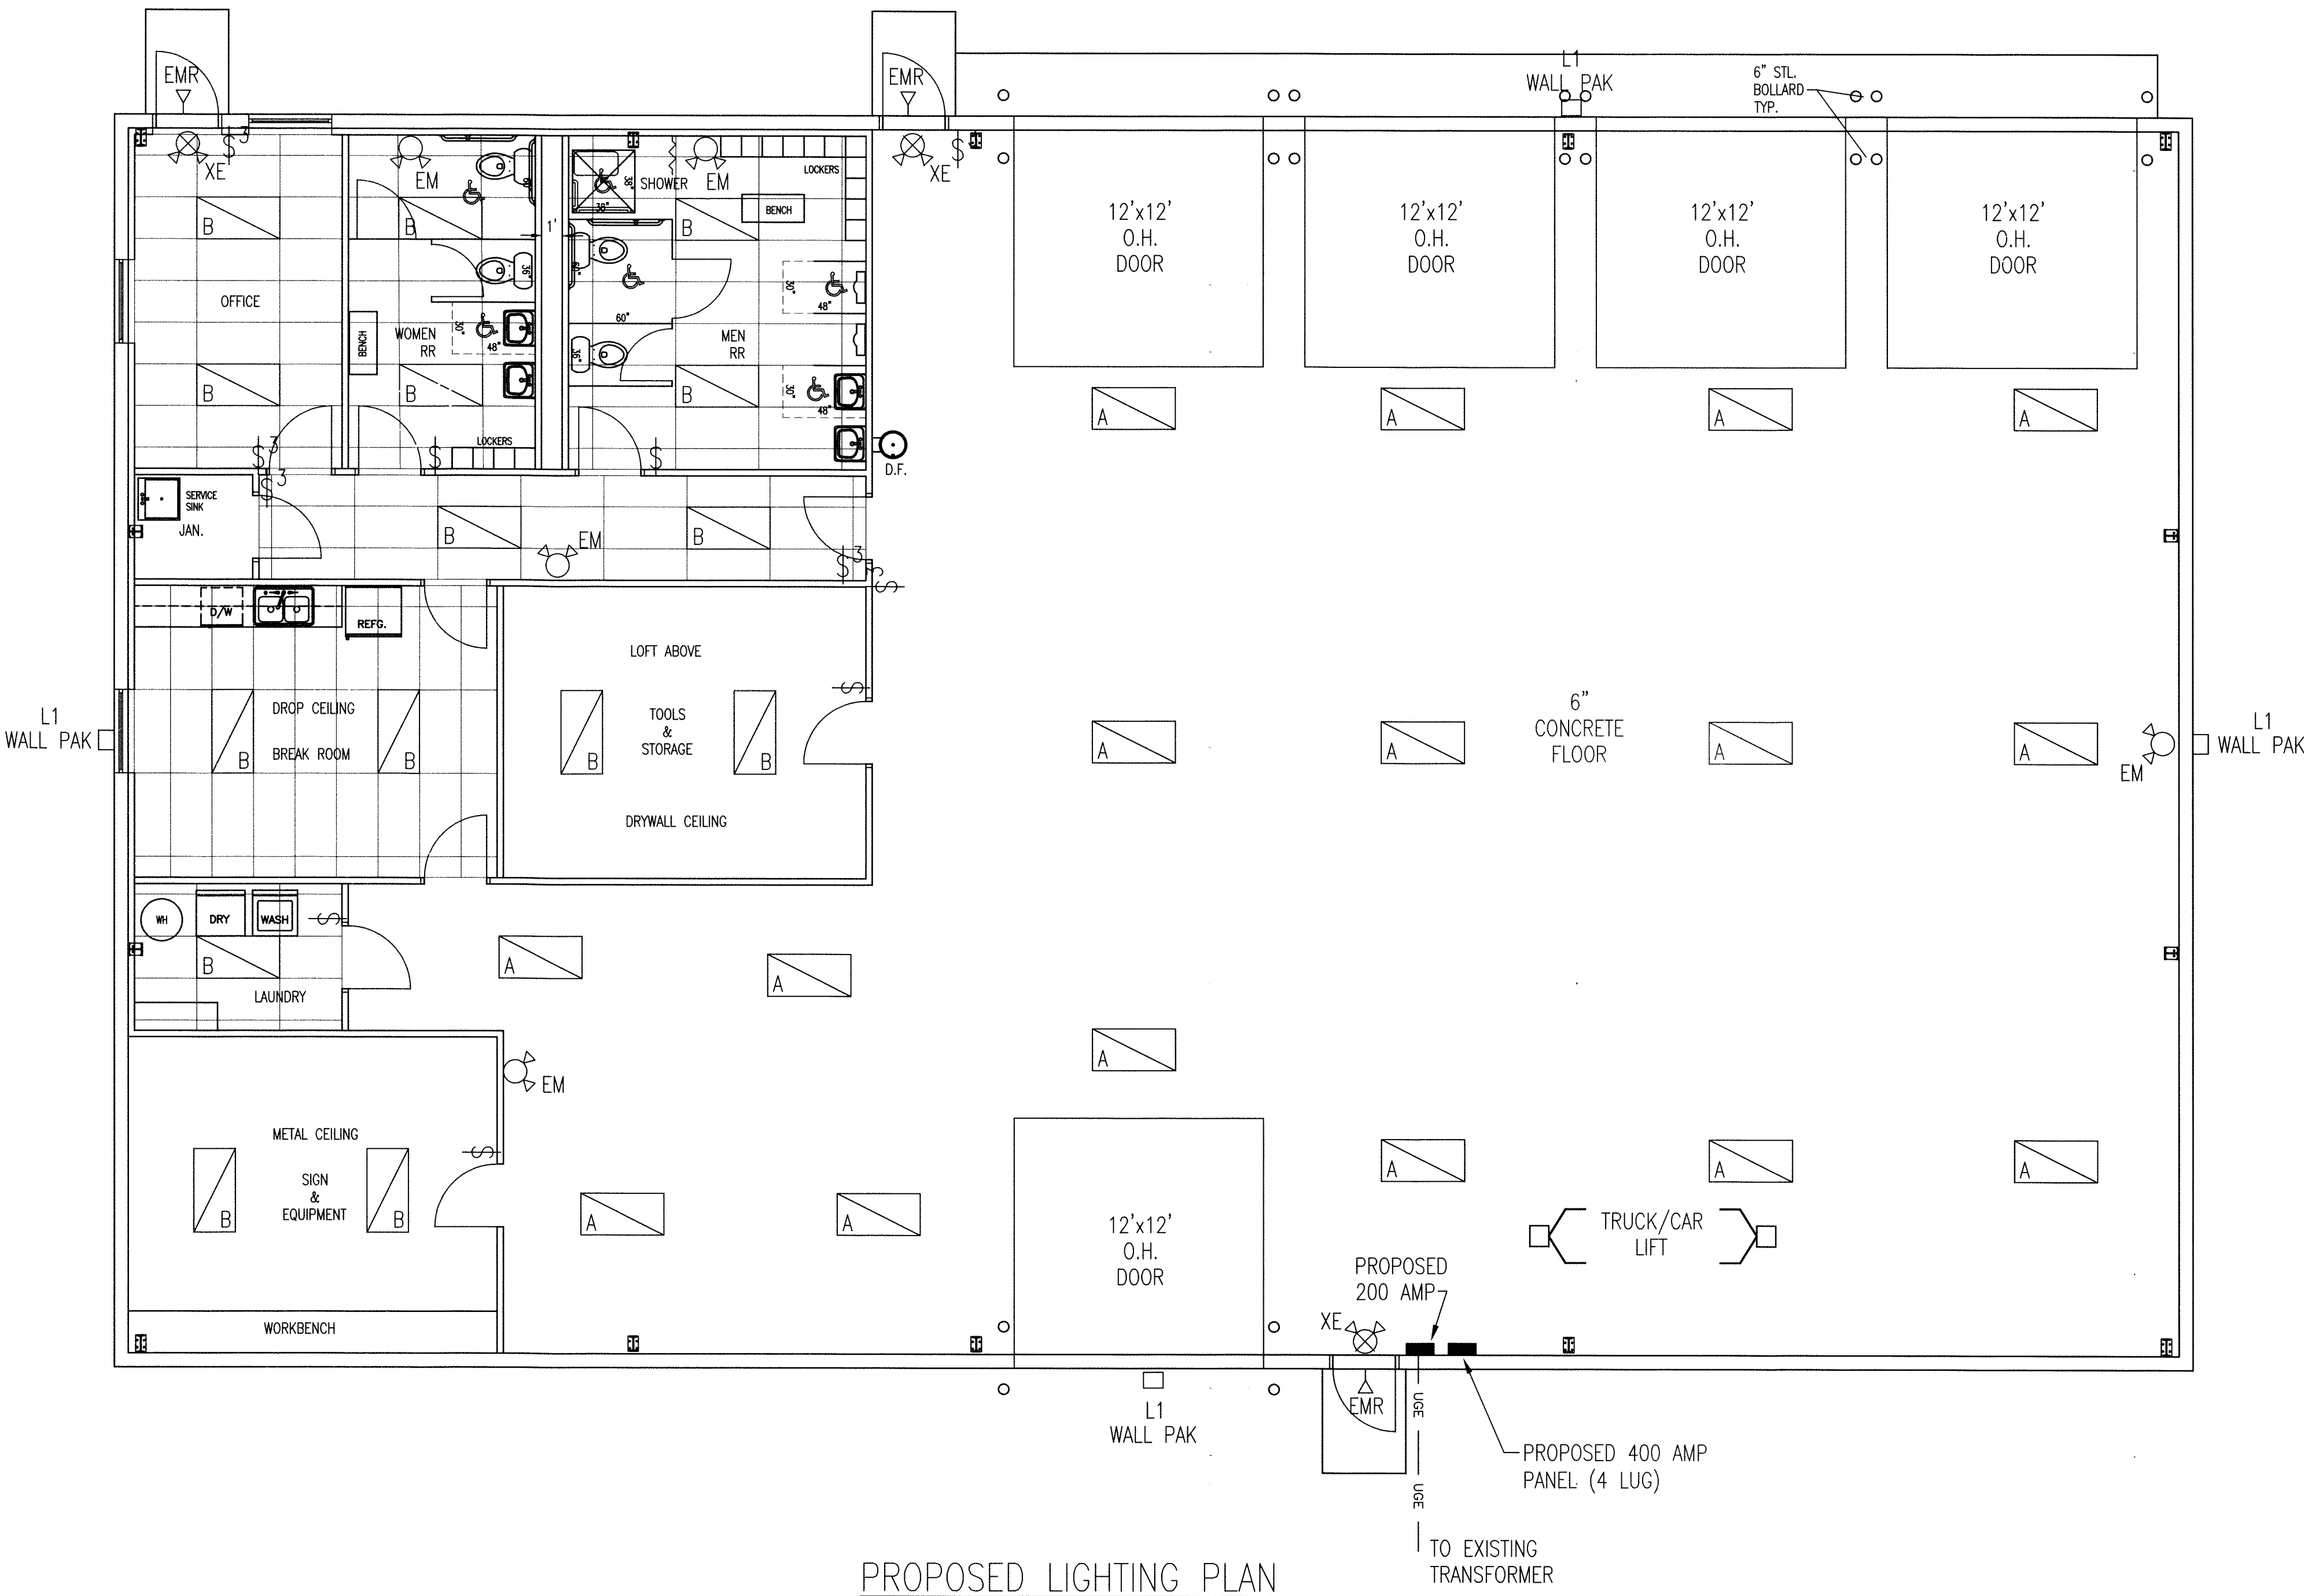
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FOR BID PURPOSES ONLY

SHEET NAME		DATE
PROPOSED ELECTRIC PLAN		6/10/19
PROJECT NAME		REVISION
SHELBYVILLE PARKS & REC. DEPT. MAINTENANCE BUILDING, BLUE RIVER PARK 1021 MORRIS AVE., SHELBYVILLE, IN 46176		REVISED PANEL
		DATE
DATE: MAY 13, 2019		
PROJECT NO.: 18015		
SHEET NO.		
E100		



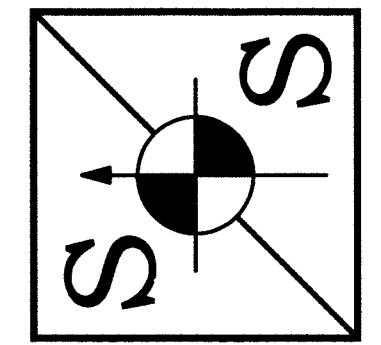

PROPOSED LIGHTING PLAN

NOTES:


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LEGEND

- \$ SINGLE POLE SWITCH
- \$<sup>3</sup> 3-WAY SWITCH
- ⊕ DUPLEX RECEPTACLE
- GFI ⊕ GROUND FAULT INTERCEPTION
- WP ⊕ WEATHERPROOF GFI RECEPTACLE
- EO ⊕ OVERHEAD DOOR RECEPTACLE
- △ DATA OPENINGS ONLY (WIRES, PLATES, JACKS BY OTHERS)
- ▭ COLUMBIA- CFP24-5540 FLAT PANEL LED
- ▭ ILP HHB 135W LED UNV 50FRL HIGH BAY FIXTURES
- XE ⊕ EXIT LIGHT W/BATTERY BACK UP W/EMERGENCY HEADS AND REMOTE CAPABILITY
- △ EMR SINGLE WEATHERPROOF REMOTE HEAD POWERED BY EXIT EMERGENCY
- EM ⊕ EMERGENCY LIGHT W/BATTERY BACK UP
- L1 WALL PAK ⊕ ILP WPCM 75W LED UNV 40K WALL PACKS
- EX-# ⊕ EXHAUST FAN-RESTROOM-75 CFM VENT TO OUTSIDE

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CHECKED	SYMBOL	REVISION	DATE
TN		REVISED PANEL	6/10/19
CERT.			
-			
SCALE			
5/16"=1'			
DRAWN			
RC			

FOR BID PURPOSES ONLY

SHEET NAME PROPOSED LIGHTING PLAN	PROJECT NAME SHELBYVILLE PARKS & REC. DEPT. MAINTENANCE BUILDING, BLUE RIVER PARK 1021 MORRIS AVE., SHELBYVILLE, IN 46176
--------------------------------------	--

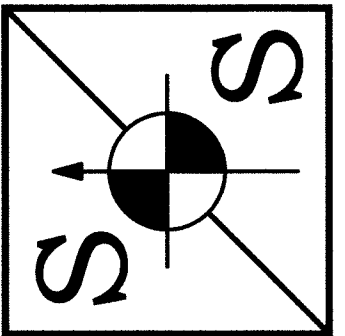DATE: MAY 13, 2019

PROJECT NO.: 18015

SHEET NO.

E101



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Architectural floor plan showing various rooms and utility areas. Key features include:

- Rooms:** OFFICE, WOMEN RR, MEN RR, SHOWER, JAN., BREAK ROOM, TOOLS & STORAGE, LAUNDRY, SIGN & EQUIPMENT, and a large open area with a 6" CONCRETE FLOOR.
- Dimensions:**
  - Rooms: 12'x12' O.H. DOOR (multiple), 12'x12' O.H. DOOR (multiple), 12'x12' O.H. DOOR (multiple), 12'x12' O.H. DOOR (multiple).
  - Overall dimensions: 29' (width), 4' (depth), 29' (length), 9' (width), 4' (depth).
- Utility Features:**
  - HOSE BIBB (multiple locations)
  - 6" STL BOLLARD TYP.
  - 40' TRENCH DRAIN
  - EMERGENCY EYEWASH/SHOWER STATION
  - 6" CONCRETE FLOOR
- Legend:** SANITARY SEWER LINE

LEGEND

— SS — SS — SS — SANITARY SEWER LINE  
— CW — CW — COLD WATER LINE  
— HW — HW — HOT WATER LINE

PROPOSED  
500 GAL.  
OIL SEPARATION  
TANK—SEE SPEC.

FIXTURE SCHEDULE					
FIXTURE	DESCRIPTION	SUPPLY		REMARKS:	QTY.
		HOT	COLD		
TOILET	AMERICAN STANDARD OR EQUAL FLOOR MOUNT, TANK TYPE		3/4	(2) ADA	4
LAV	AMERICAN STANDARD OR EQUAL WALL HUNG, SINGLE FAUCET	1/2	1/2	(2) ADA	4
URINAL	AMERICAN STANDARD OR EQUAL WALL HUNG, SLOAN VALVE		1/2	(1) ADA	2
SERVICE SINK	MUSTEE OR EQUAL STAINLESS STEEL, FAUCET	1/2	1/2		1
FLOOR DRAIN	ZURN OR EQUAL W/ CLEAN OUT			(6)-2", (1)-3"	7
TRENCH DRAIN	ZURN OR EQUAL W/ CLEAN OUT			(1) 40" LENGTH	1
WATER HEATER	A.O. SMITH OR EQUAL 75 GAL., GAS,	1/2	1/2		1
CLEAN OUT	CHARLOTTE OR EQUAL -				2
HOSE BIBB	WOODFORD OR EQUAL ANTI-FREEZE, ANTI-SYPHON		1/2		3
2 COMP. SINK	ELKAY OR EQUAL STAINLESS STEEL, FAUCET	1/2	1/2	DELTA 400 FAUCET, BADGER V DISPOSAL	1
SHOWER	DIAMOND 38"x38" OR EQUAL ACRYLUX, FAUCET	1/2	1/2	ADA, 38"x38"	1
EMERGENCY EYE WASH/SHOWER	BRADLEY OR EQUAL	1/2	1/2	S19314 SERIES	1
BACKFLOW PREVENTER	WATTS, MODEL 009			1 1/4", 18" A.F.F.	1
OIL SEPARATOR	MCCREARY CONCRETE PRODUCTS 500 GAL. OIL INTERCEPTOR			MCCREARY CONCRETE PRODUCTS, INC. RUSHVILLE, INDIANA 765-932-3058	1
TOILET PARTITIONS	AMERICAN SANITARY PARTITION CORP. OR EQUAL			TYPE: BE-FS	-
DRINKING FOUNTAINS	ELKAY OR EQUAL -		1/2	ADA, EZ38, WALL MOUNT	1
LOCKERS	BY OWNER				


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NOT BE SHOWN ON PLANS.

ANY WALL WITHIN 2' OF THE WATER CLOSET SHALL BE COVERED WITH TOUGH  
ROCK MOLD GUARD GYPSUM BOARD (GREEN BOARD) AND HAVE A FINISH.

USE SCH 40 PVC FOR WASTE PLUMBING LINE.

USE WIRSBO PEX FOR WATER LINE.

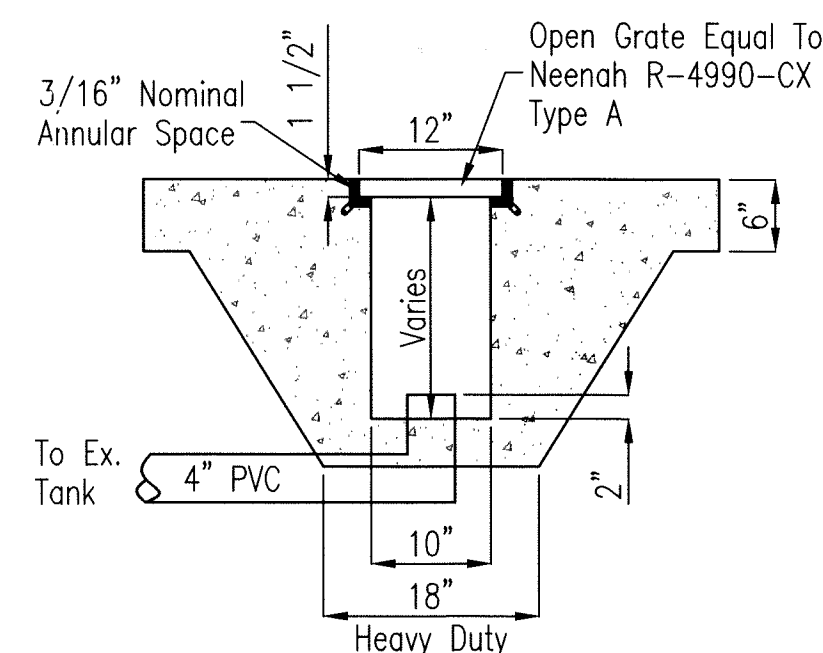

Trench Detail  
No Scale


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DATE	5/10/19
------	---------

REVISION

CHECKED	SYMBOL
	TN

1

**SHEET NAME**

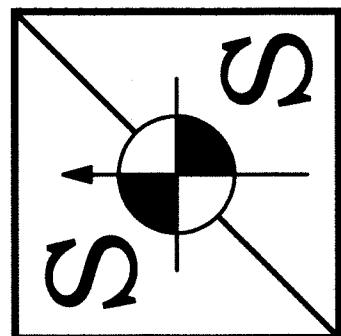**SHEET NAME**  
**ED PLUMBING**

SHELBYVILLE PARKS & REC. DEPT.  
MAINTENANCE BUILDING, BLUE RIVER PARK  
1021 MORRIS AVE., SHELBYVILLE, IN 46176

DATE: MAY 13, 2019

PROJECT NO.: 18015

SHEET NO.

P100

