CITY OF SHELBYVILLE

Adam M Rude Director



Allan Henderson Deputy Director

PLAN COMMISSION

MEETING DATE: 07/24/2023

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Case Number & Name:	PC 2023-15; Early Learning Center; SDP						
Petitioner's Name:	Runnebohm Construction, Inc						
Owner's Name:	Major Health Partners						
Petitioner's	Andrew Swanson, JPS	Consulting Engineers					
Representative:	Andrew Swanson, Jrs	Consulting Engineers					
Address of Property:	2400 Intelliplex Drive,	Shelbyville, IN					
Subject Property	PD - Planned Develop	ment					
Zoning Classification:	1 D - Trainied Develop	micht					
Comprehensive Future	Single Family Resident	ial					
Land use:	·						
	North	East	South	West			
		RM – Multiple-family					
Surrounding Properties'	PD - Planned	Residential & R1 –	PD - Planned	PD - Planned			
Zoning Classifications:	Development	Single Family	Development	Development			
		Residential					
Surrounding Properties'	Single Family	Single Family	High-Tech/Light	High-Tech/ Light			
Future Land Use	Residential	Residential	Industrial	Industrial			
	The site is part of the 142-acre Intelliplex Planned Unite Development created in 2003 to be a						
History:	mix of medical, life sciences, business, and neighborhood services. The Julia and Nicholas						
	Runnebohm Early Learning Center will utilize 3.6 acres of Intelliplex.						
Vicinity Map:	70	EASSENCE OF THE PROPERTY OF TH	TUREWAY 00 20 104 104 104 104 104 104	600 RAFFERT 670 670 68			
Action Requested:		elopment Plan approval	for the construction of a	a daycare and			
neuon nequesteu.	education center.						

Facts of the Case:

- The petitioner is proposing to construct a 25,000 square foot facility on 3.6 acres. The facility will provide early learning opportunities to children from infant to Pre-K. The facility will accommodate up to approximately 200 children when at full capacity. Each age group will have up to (4) four classrooms and a dedicated playground/outdoor learning environment.
- The Intelliplex Architectural Review Committee has reviewed the plans and granted approval of building elevations and architectural materials.
- The facility will be constructed in (2) two phases.

1. The Zoning Ordinance (Section 9.05 (F) (5)) requires the Plan Commission make Findings of Fact that the Site Development Plan:

a. Is consistent with the City of Shelbyville Comprehensive Plan:

The planning staff has determined the subject petition is consistent with the goals of the Comprehensive Plan. A focus of the Comprehensive Plan is:

Community and Society

Objective 4: Invest in Improving Our Quality of Life

Action 1: Identify quality of life elements within the CIP plan.

Built Environment

Objective 2: Guide Healthy development Patterns Using the Future Land Use Map

Action 3: Target mixed-use flexibility for gateway development.

Commerce and Economy

Objective 5: Support Local Business Retention and Creation.

Action 2: Continue marketing Intelliplex as a small business incubator hub to encourage businesses to develop, build and grow.

The site for this subject petition is located in the Intelliplex PUD which has been designed as a mix of medical, life sciences, business, and neighborhood services. Daycare facilities fall under the category of neighborhood/supportive services.

Meets the Technical Review Committee's expectations for best practices and quality design:

The Technical Review Committee reviewed the site development plan against their applicable standards. The petitioner has responded and addressed the Technical Review Committee's comments.

This project went to the Technical Review Committee on March 28th, 2023, where the petitioner was able to present their project and answer questions of the committee members. Since that time, the petitioner has addressed all comments and corrections identified by the committee members, aside from a few small comments from the Engineering Department in regard to drainage. In speaking with the Engineering Department, it appears that the outstanding drainage-related comments are small and mostly clarifying pieces of information about the drainage report, and their staff feels confident that approving petition can be approved contingent on their office being provided this additional information and them reviewing and approving any needed changes to the drainage report or plans. For this reason, we will be recommending a condition that the City Engineering Department review and approve revised drainage plans and reports.

c. Satisfies the applicable requirements of Article 2: Zoning Districts:

The planning staff has determined the subject petition is consistent with the PD – Planned Development district established for Intelliplex more particularly the GB _ General Business district within the overall planned unit development. Based on the "Table of Permitted Land Uses" included in the Intelliplex Planned Unite Development Detailed Plan, day-care centers are permitted in the GB – General Business district. The GB – General Business district is intended to accommodate a variety of business uses generally focused on life-sciences and involving research and development, technology, light manufacturing and assembly, data processing, and professional offices.

d. Satisfies the applicable requirements of Article 5: Development Standards:

Planning Staff has worked with the petitioner to satisfy the standards of Article 5 of the Unified Development Ordinance.

Architectural Standards: Architectural Standards for projects located within Intelliplex are identified in the Intelliplex Planned Unit Development Detailed Plan. The Detailed Plan requires building materials to be a combination of brick, native stone, architectural pre-cast concrete, and/or architectural metal. The primary material for the front façade of the building is brick veneer with a limestone band. The primary materials for the rear and sides of the building are brick veneer and fiber cement lap siding. In addition, the facility is incorporating the two required design features in the roof of the building, meeting the roof requirement. The petitioner is satisfying all applicable Architectural Standards.

Entrance and Drive Standards: Entrance and Drive Standards are detailed in UDO 5.15 Non-residential Driveway Standards. These standards specify an access road shall be at least twenty (20) feet wide, but not exceed twelve (12) feet per lane and thirty-six (36) feet in overall width. The facility is utilizing an existing driveway cut along Intelliplex Drive and the proposed internal access drives are twenty (20) feet in width, under the thirty-six (36) foot maximum. The petitioner is satisfying all applicable Entrance and Drive Standards.

Fence, Hedge, and Wall Standards: Fence, Hedge, and Wall Standards are detailed in UDO 5.19 Parks & Recreation and Business Fence, Hedge, and Wall Standards. The standards specify that fence height cannot exceed eight (8) feet in these districts. The facility is utilizing a six (6) foot fence around the playground spaces. The petitioner is satisfying all applicable Fence, Hedge, and Wall Standards.

Landscaping Standards: Landscape Standards for projects located within Intelliplex are identified in the Intelliplex Planned Unit Development Detailed Plan. The Detailed Plan requires landscaping such that all portions of every lot not occupied by structures, parking areas, or other paved surfaces shall be design, constructed, and maintained in a cultivated landscape condition. Landscape requirement

- 1) Lot Yard Areas
- 2) Parking Lot Perimeter
- Parking Lot Interior

The facility was able to satisfy all the requirements for of the Lot Yard Area, Parking Lot Perimeter and the Parking Lot Interior plantings. Not only was the project able to meet the standards, but almost doubled the landscape requirements for Parking Lot Perimeter and the Parking Lot Interior plantings. The petitioner is satisfying all applicable Landscape Standards.

Parking Standards: Parking Standards are detailed in UDO 5.52 Non-residential Parking Standards. The standards specify that two (2) parking spaces are required for every classroom in an elementary school. The first phase of the facility will contain ten (10) classrooms requiring twenty (20) parking spaces. Forty-three (43) parking spaces have been provided. The petitioner is satisfying all applicable Non-residential Parking Standards.

Other Standards: The planning staff has conducted numerous reviews of this project and all other applicable standards within Article 5 of the UDO have been satisfied.

- e. Satisfies the applicable requirements of Article 6: Design Standards
 Article 6: Design Standards provides the standards for all subdivisions and generally apply to the construction of residential planned unit developments with public improvements. Article 6: Design Standards do not apply to this project.
- f. Satisfies any other applicable provisions of the Unified Development Ordinance. All other applicable provisions of the Unified Development Ordinance are satisfied by the submitted civil plans.

STAFF RECOMMENDATION: APPROVAL

Site Development Plan: PC 2023-15; Early Learning Center; SDP

Findings of Fact by the Shelbyville Plan Commission

Staff Prepared

	Motion: (I) would like to make a motion to approve the site development plan as presented to this body pursuant to the planning staff's report and Findings of Fact.	
1.		
	planning staff's report. The site development plan is not consistent with the <i>City of Shelbyville Comprehensive Plan</i> , as outlined in the	
	planning staff's report.	
2.		y
	design, as outlined in the planning staff's report, as outlined in the planning staff's report.	_1
	The site development plan does not meet the Technical Review Committee's expectations for best practices an	
3.	quality design, as outlined in the planning staff's report, as outlined in the planning staff's report The site development plan satisfies the applicable requirements of Article 2: Zoning Districts, as outlined in the	_
э.	planning staff's report.	5
	The site development plan does not satisfy the applicable requirements of Article 2:.Zoning Districts, as outline	d
	in the planning staff's report.	-
4.	The site development plan satisfies the applicable requirements of Article 5: Development Standards, as outline	d
	in the planning staff's report.	
	The site development plan does not satisfy the applicable requirements of Article 5:.Development Standards, a	S
	outlined in the planning staff's report.	
5.	The site development plan satisfies the applicable requirements of Article 6: Design Standards, as outlined in the	Э
	planning staff's report.	
	The site development plan does not satisfy the applicable requirements of Article 6: Design Standards, as outline	d
_	by the planning staff's report.	
6.		s
	outlined by the planning staff's report.	
	The site development plan does not satisfy all other applicable provision of the Unified Development Ordinance as outlined in the planning staff's report.	į,
	as outlined in the planning stans report.	
Addi	itional Conditions Imposed by the Shelbyville Plan Commission:	
1	1.	
,	2.	
4	Σ.	
3	3.	
Shel	lbyville Plan Commission	
Ву: _	Attest:	
	Chairperson / Presiding Officer Adam M. Rude, Secretary	



SITE DEVELOPMENT PLAN APPLICATION
Shelbyville Planning & Building Department
44 West Washington Street
Shelbyville, IN 46176
P: 317.392.5102


For Office Use Only:	
Case #: PC	
Hearing Date:	
Fees Paid: \$	
Final Decision:	
Approved	Denied
	- 1

				Approved	Denied
1.					
A	pplicant	Р	roperty Owners Inform	nation (if different t	han Annlicant)
	ame: Runnebohm Construction, Inc	N	ame: Major Health I	Partners	man Apphoant,
A	ddress: 144 E Rampart St.		ddress: 2451 Intellip		
_	Shelbyville, IN 46176	_	Shelbyville, I		
PI	none Number:317-716-0163	PI	none Number: 317-84	0-6609	
Fa	x Number:	Fa	ax Number:		
Er	nail: klasure@runnebohm.com	_ Er	nail: _jwilliams@ma	ajorhospital.org	
2.					
	pplicant's Attorney/Representative		Project Engineer		
Na	ame:	_ Na	ame: Andrew Swa	nson, PE	
Ad	ldress:	_ Ac	Idress: 9365 Couns		116
-			Indianapolis		
Ph	one Number:	_ Ph	one Number: (317)	694-8291	
Fa	x Number:		x Number:		
En	nail:	_ En	nail: aswanson@jp	sce.com	
Cu	reneral Location of Property (and address is applicable):2400 rent Zoning:Planned Unit Development (Intelliplex) posed Zoning: Planned Unit Development (Intelliplex)		Existing Use of Pro	perty: Vacant	
4.	Attachments				
K	Affidavit and Consent of Property Owner (if applicable)	100	Lighting Plan		
×	Proof of Ownership (copy of deed, recent property card)	24	Landscaping Plan		
	Letter of Intent	(80)	Drainage Plan and R	eport	
X	Civil Plans as prescribed in UDO 9.05	20	Dimensioned Site Pla	(8)	
X	Vicinity Map		Filling Fee		
	e undersigned states the above information is true as			/ /	
R	otary Public, State of Indiana	this5	day of Jun	28 more To	<u>s</u> .
Co	Wayne County ommission Number 6915 Residing in My Commission Expires November 30, 2024	ounty.	My Commission	Expires:	30,2024

AFFIDAVIT & CONSENT OF PROPERTY OWNER

APPLICATION TO THE SHELBYVILLE PLAN COMMISSION

COUNTY OF Shelby SS:
I, Major Health Partners, AFTER BEING DULY SWORN, DEPOSE AND SAY THE (Name of property owner) FOLLOWING:
That I am the owner of real estate located at2400 Intelliplex Drive, Shelbyville, IN 46176; (Address of subject property)
That I have read and examined the Application made to the Shelbyville Plan Commission by: Runnebohm Construction, Inc (Name of applicant)
 That I have no objections to, and consent to the request(s) described in the Application made to the Shelbyville Plan Commission.
Jeff Williams Owner's Name (Please/Print)
ROBERT M. SIZEMORE JR. Notary Public, State of Indiana Wayne County Commission Number 691541 Owner & Signature
My Commission Expires November 30, 2024
Subscribed and sworn to before me this 5th day of June, 2023. Rob ent M. Sizeman J. Notany Public Printed
Residing in Warn & County My Commission expires Nov 30, 2024

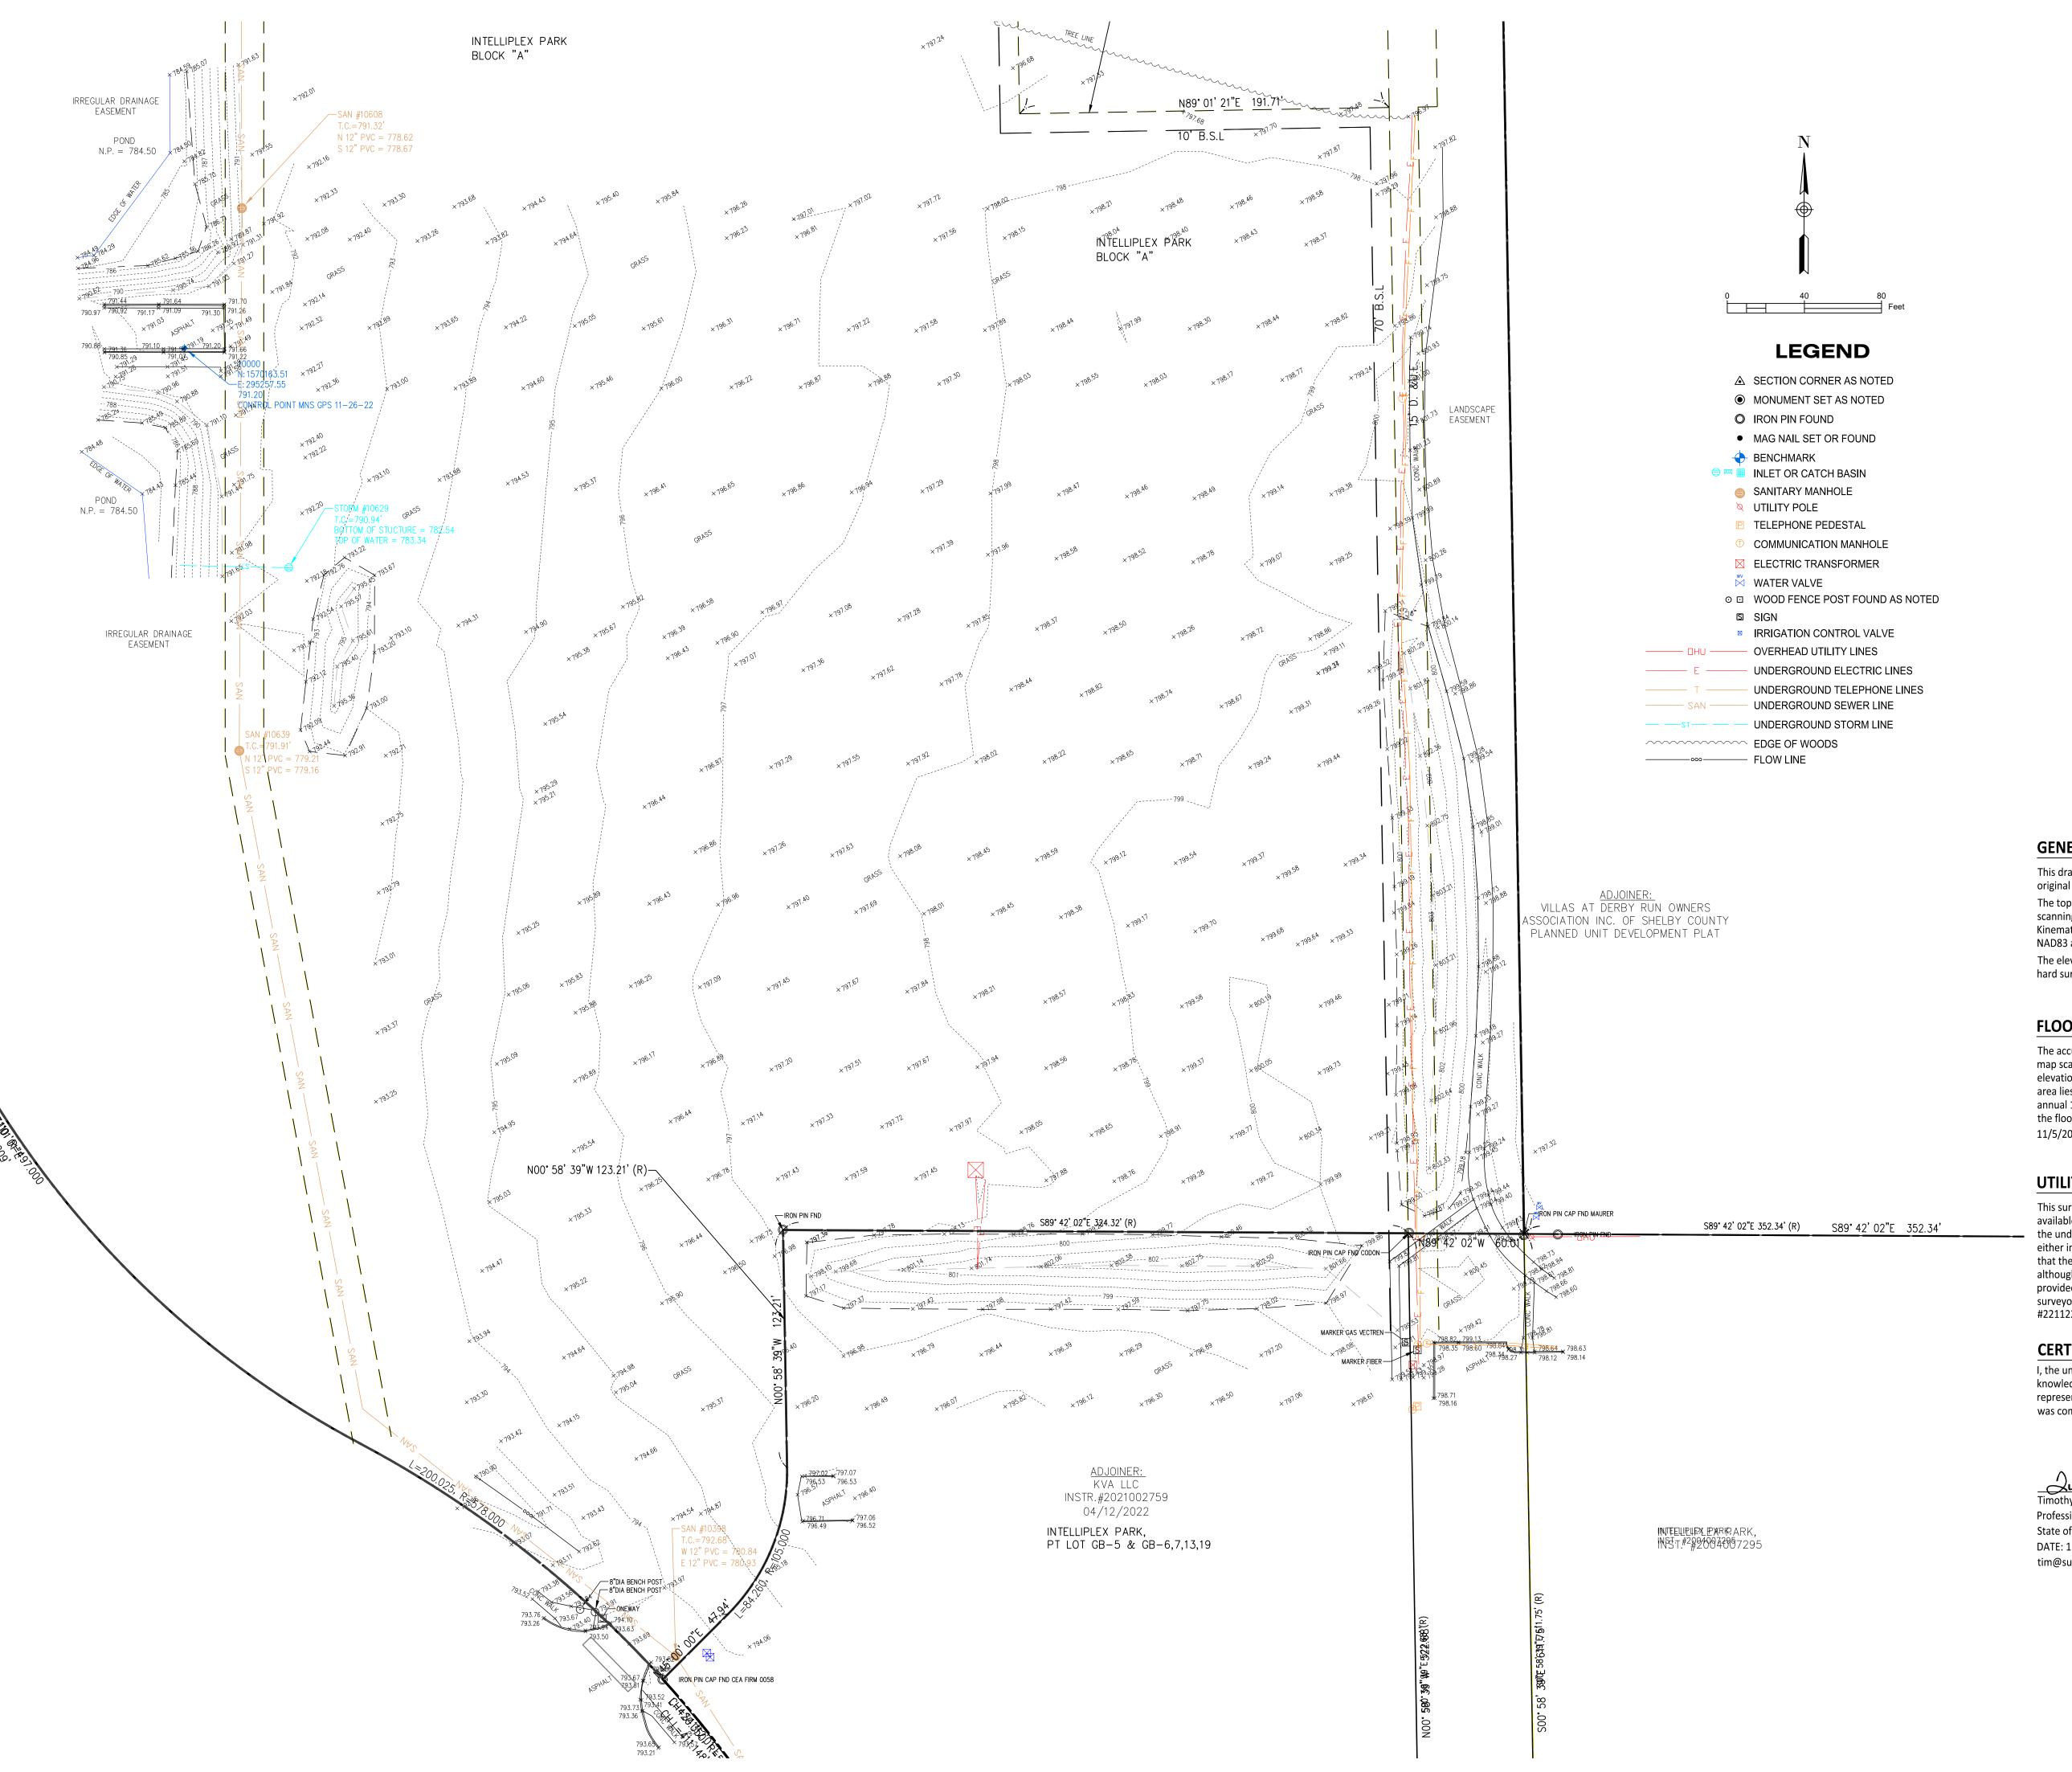



LOCATION MAP N.T.S.

GENERAL NOTES:

This drawing is not intended to be represented as a retracement or original boundary survey, a route survey or a Surveyor Location Report. The topographic data was gathered using 3D high definition laser scanning, and by global positioning equipment, utilizing the Real Time Kinematic Rovers on the Indiana GPS Network, NTRIP using State Plane NAD83 and NAVD88 Geiod12.

The elevations on natural surfaces are accurate to within 0.10 feet and on hard surfaces to within 0.05 feet.

FLOOD STATEMENT

The accuracy of any Flood Hazard Data shown on this survey is subject to map scale uncertainty and to any other uncertainty in location or elevation on the referenced flood insurance rate map. The Subject survey area lies within that Special Flood Hazard Zone X (areas outside of the annual 1% chance of flooding) per COMMUNITY PANEL # 18145C0116C of the flood insurance rate maps for Shelby County, Indiana dated 11/5/2014.

UTILITIES

This survey reflects above ground indications of utilities and information available from utility companies. The surveyor makes no guarantee that the underground utilities shown comprise all such utilities in the area, either in service or abandoned. The surveyor further does not warrant that the underground utilities shown are in the exact location indicated, although they are located as well as possible based upon the information provided. Except as indicated by invert elevations on sewer lines the surveyor has not physically located the underground utilities. IUPPS #2211221665

CERTIFICATION

I, the undersigned hereby certify that to the best of my professional knowledge and belief that the within topographic survey plat accurately represents a survey performed under my supervision. The field survey was completed 11/26/2022.

Timothy D. Highie D.S. Professional Surveyor #20100067 State of Indiana DATE: 12/1/2022 tim@surveyfirst.net



SURVEY

SURVE

SURVEY

SHEET NO.: **1** 0F **1** **ADAM RUDE**

PLANNING DIRECTOR 44 W Washington St. Shelbyville, IN 46176 TEL: 317.392.5102

EMAIL: arude@cityofshelbyvillein.com ____ Released via TRC Form

DOUG HUNT STREET COMMISSIONER

605 Hale Road Shelbyville, IN 46176 TEL: 317.392.5169 EMAIL: dhunt@cityofshelbyvillein.com ____ Released via TRC Form

TRAVIS EDINGTON INDIANA AMERICAN WATER 1700 McCall Dr. P.O. Box 418 Shelbyville, IN 46176

TEL: 317.392.0711 EMAIL: travis.edington@amwater.com ____ Released via TRC Form

TROY BISHOP

420 East 7th Street Columbus, IN 47201 TEL: 812.376.2887 EMAIL: tb2932@att.com ____ Released via TRC Form

ALLAN HENDERSON DEPUTY PLANNING DIRECTOR 44 W Washington St.

Shelbyville, IN 46176 TEL: 317.392.5102 EMAIL: ahenderson@cityofshelbyvillein.com ____ Released via TRC Form

MARK WEIDNER CHIEF OF POLICE 105 West Taylor St. Shelbyville, IN 46176 TEL: 317.392.5106 EMAIL: mweidner@cityofshelbyvillein.com

_____ Released via TRC Form

MARY BARBER/MOSTAFA KHALLAD 600 Industrial Dr. Franklin, IN 46131

TEL: 317.736.2965 EMAIL: mbarber@vectren.com/mkhallad@vectren.com _____ Released via TRC Form

TOM DAVIS COMCAST 1470 Jackson Street Columbus, IN 47201 TEL: 812.799.0915 EXT. 3108 EMAIL: Thomas davis3@cable.comcast.com ____ Released via TRC Form

MATTHEW HOUSE, PE CITY ENGINEER

44 W Washington St. Shelbyville, IN 46176 TEL: 317.392.5102 EMAIL: mhouse@cityofshelbyvillein.com ____ Released via TRC Form

BRADLEY FIX

DERRICK BYERS

MS4 OPERATOR

44 W Washington St

Shelbyville, IN 46176

_____ Released via TRC Form

TEL: 317.392.5102

CHRIS CHASTAIN

Manilla, IN 46150

TEL: 765.544.2600

RUSH/SHELBY ENERGY

2777 S 840 W PO Box 55

____ Released via TRC Form

DEWAYNE HAMILTON

TEL: 317.966.3356

FIBER OPTIC-CENTURYLINK

____ Released via TRC Form

EMAIL: dewayne.hamilton@level3.com

EMAIL: cchastain@rse.coop

WRRF SUPERINTENDENT

775 West Boggstown Rd.

____ Released via TRC Form

EMAIL: befix@cityofshelbyvillein.com

EMAIL: dbyers@cityofshelbyvillein.com

Shelbyville, IN 46176 TEL: 317.392.5131

RYAN ANGRICK SHELBYVILLE FIRE DEPARTMENT 40 West Broadway St. Shelbyville, IN 46176 TEL: 317-699-0179

EMAIL: rangrick@cityofshelbyvillein.com ____ Released via TRC Form JOSH HORNBERGER DUKE ENERGY

2910 East State Road 44 Shelbyville, IN 46176 TEL: 317.398.5361 EMAIL: joshua.hornberger@duke-energy.com ____ Released via TRC Form

TAYLOR SUMMERFORD SHELBY COUNTY SURVEYOR 25 W Polk St., Room B020 Shelbyville, IN 46176 TEL: 317.392.6481 EMAIL: norma.ross@co.shelby.in.us ____ Released via TRC Form

GENERAL NOTES

1. THE CONTRACTOR SHALL BE RESPONSIBLE FOR OBTAINING, AND VERIFYING, THAT ALL PERMITS AND APPROVALS ARE OBTAINED FROM THE RESPECTIVE CITY, COUNTY, STATE AND FEDERAL AGENCIES PRIOR TO STARTING CONSTRUCTION.

2. CONTRACTOR SHALL VERIFY LOCATION AND INVERT ELEVATIONS OF EXISTING SEWERS PRIOR TO START OF CONSTRUCTION.

3. CONTRACTOR SHALL MAINTAIN A COMPLETE AND OPERABLE UTILITY SYSTEM AT ALL TIMES.

CONTRACTOR SHALL INCLUDE COSTS FOR CUTTING AND PATCHING AS REQUIRED IN THEIR BID PROPOSAL TO COMPLETELY INSTALL THE WORK INDICATED.

CONTRACTOR SHALL INCLUDE ALL TAP FEES, PERMIT FEES AND APPLICATION FEES IN THEIR BID PROPOSAL AS NECESSARY TO COMPLETELY INSTALL THE WORK INDICATED.


INFORMATION SHOWN WAS OBTAINED FROM AN OWNER FURNISHED SITE SURVEY OF EXISTING CONDITIONS AND IS UNCONFIRMED. CONTRACTOR IS REQUIRED TO FIELD VERIFY THIS INFORMATION AND NOTIFY ARCHITECT OF ANY DISCREPANCIES SO MODIFICATION CAN

CONTRACTOR SHALL COORDINATE EXACT UTILITY LOCATIONS WITH THE OWNER AND LOCAL UTILITY COMPANIES PRIOR TO COMMENCING ANY WORK. UTILIZE THE INDIANA UNDERGROUND UTILITY LOCATION SERVICE AT 811 OR 800-382-5544 PRIOR TO ANY EXCAVATION ON THE SITE.

SITE SYMBOLS

(RCP) PIPE MATERIAL

AND ABBREVIATIONS

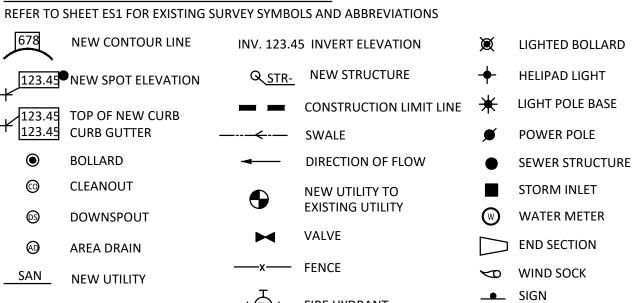

FIRE HYDRANT

TW (TYP)

UNDERGROUND

WATER VALVE

COMMUNICATION

FIBER OPTICS

WATER

O HANDHOLE/PULL BOX \sim FLAG POLE FIRE DEPARTMENT CONNECTION ■ PARKING BUMPER TRANSFORMER **GAS METER** ADA RAMP POST INDICATOR VALVE ELECTRIC MANHOLE ACCESSIBLE PARKING SYMBOL TOP OF WALL
TYPICAL

HIGH DENSITY AREA DRAIN POLYETHYLENE PIPE **BOTTOM OF WALL** MATCH EXISTING CATCH BASIN INV INVERT ELEVATION CLEANOUT MANHOLE DUCTILE IRON PIPE OVERHEAD DOWNSPOUT POST INDICATOR VALVE EXISTING GRADE

POLYVINYL CHLORIDE PIPE REINFORCED CONCRETE HP EXISTING FIRE DEPARTMENT CONNECTION SANITARY SEWER STORM SEWER FIRE HYDRANT **TELEPHONE** TOP OF CASTING ELEVATION CHILLED WATER RETURN CWS - CHILLED WATER SUPPLY CWR

LOCATION MAP

PROJECT SITE



VICINITY MAP


Soil Map-Shelby County, Indiana Still blap may not be walld at this scale.

ow what's **below.** 811 before you dig.

MAP LEGEND MAP INFORMATION The soil surveys that comprise your AOI were mapped at Warning: Soil Map may not be valid at this scale Very Starry Spat Soil Map Unit Polygon Enlargement of maps beyond the scale of mapping can cause Wet Spot Soil Map Unit Lines misunderstanding of the detail of mapping and accuracy of soil line placement. The maps do not show the small areas of Soil Map Unit Points ontrasting soils that could have been shown at a more detailed (c) Binwout Please rely on the bar scale on each map sheet for map Borrow Pa Clay Spot Source of Map: Natural Resources Conservation Service Maps from the Web Soil Survey are based on the Web Mercator distance and area. A projection that preserves area, such as the Albers equal-area conic projection, should be used if more Lava Flow accurate calculations of distance or area are required. This product is generated from the USDA-NRCS certified data as Marsh or swamp of the version date(s) listed below. Mine or Quarry Soil Survey Area: Shelby County, Indiana Survey Area Data: Version 26, Sep 2, 2022 Miscellaneous Water Perennial Water Soil map units are labeled (as space allows) for map scales Rock Outcrop Date(s) aerial images were photographed: Jun 15, 2022—Jun - Salme Spot Sandy Spot Severety Enoded Spot compiled and digilized probably differs from the background imagery displayed on these maps. As a result, some minor Sinkhale shifting of map unit boundaries may be evident. Slide or Slip Sodic Spot


Map Unit Symbol	Map Unit Name	Acres in AOI	Percent of AOI
Br	Brookston silty clay loam, 0 to 2 percent slopes	11.3	28.7%
CrA	Crosby sift foam, New Castle Till Plain, 0 to 2 percent slopes	25.4	64.7%
W	Water	2.6	6.5%
Totals for Area of Interest		39.2	100.0%

SOILS MAP

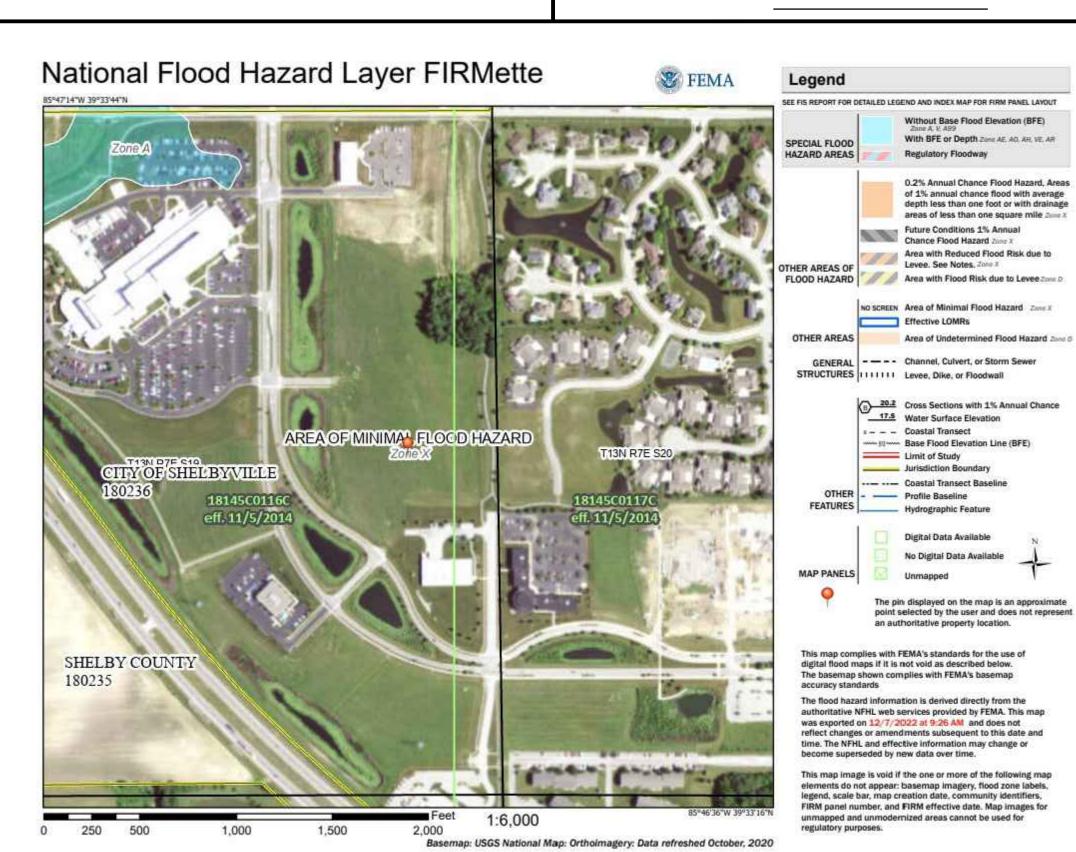


FLOOD MAP

CONSTRUCTION **DOCUMENTS**

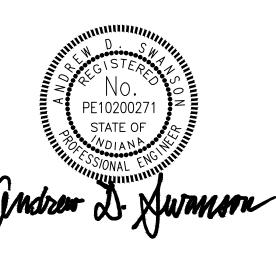


PROJECT INFORMATION


SCALE: NO SCALE MAY 31, 2023 PROJECT #: 22JPSC83 DRAWN: COORD: APPROVED: ADS

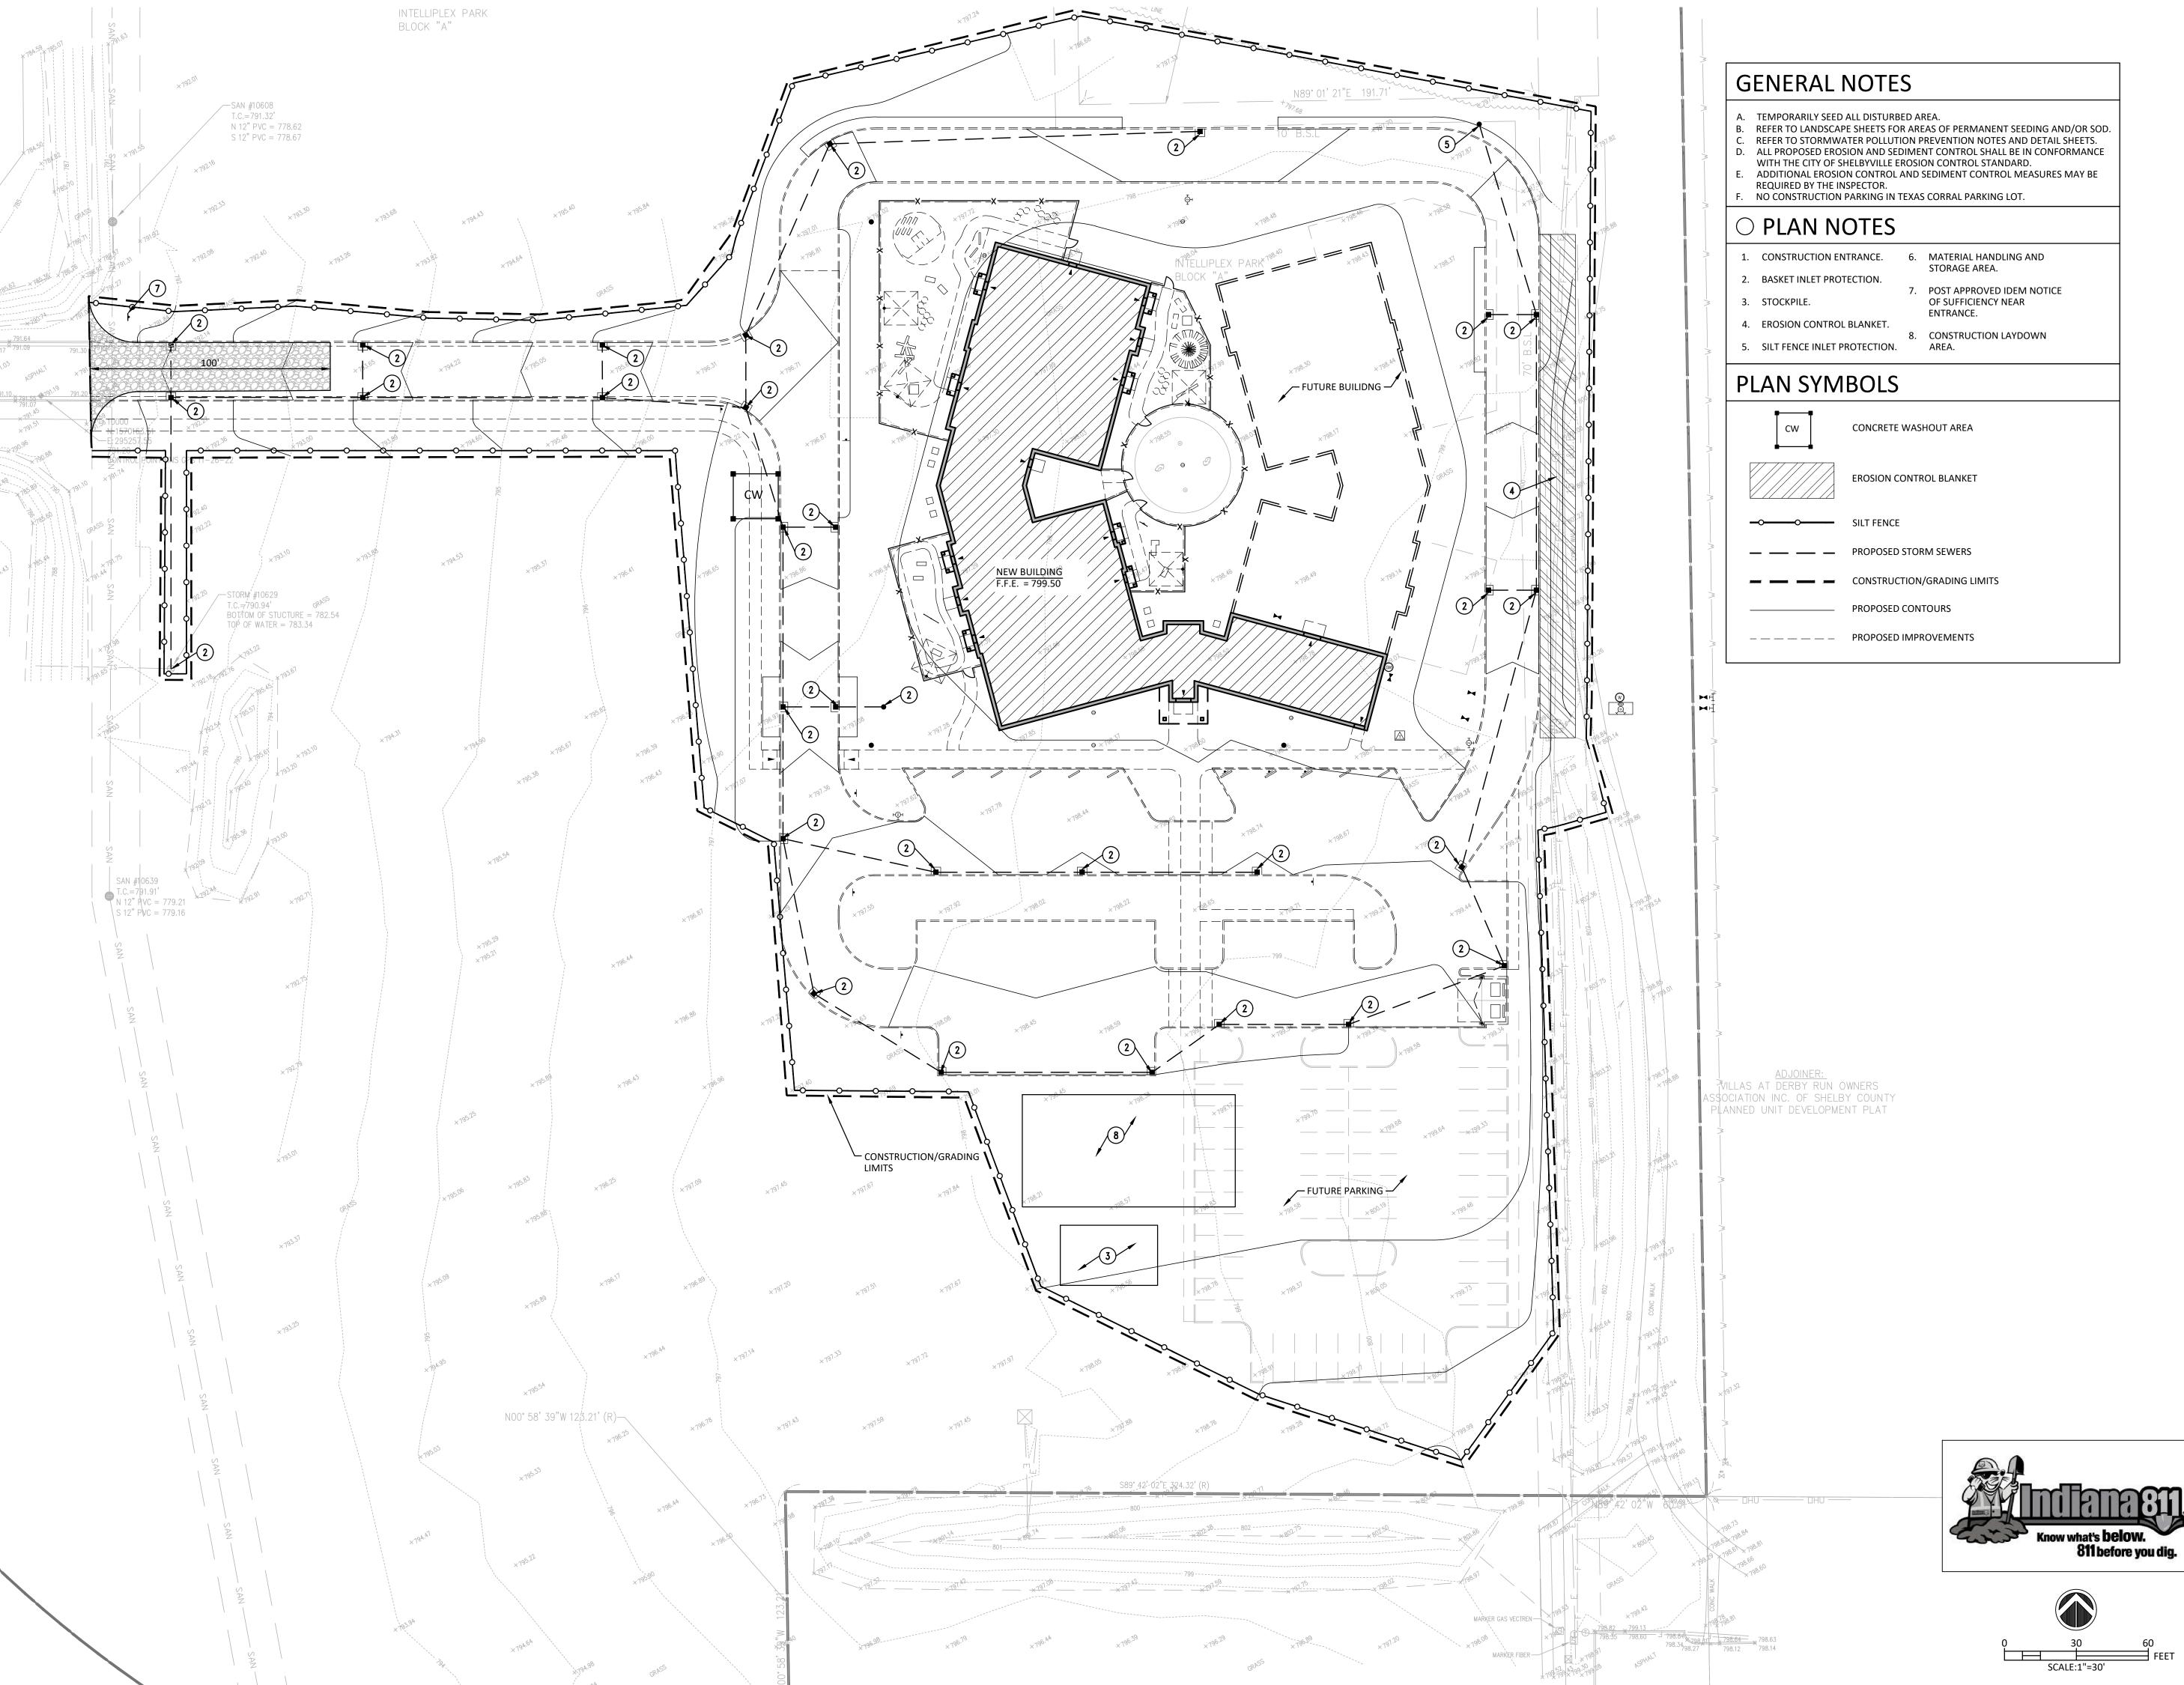

- B. REFER TO LANDSCAPE SHEETS FOR AREAS OF PERMANENT SEEDING AND/OR SOD

CONSTRUCTION **DOCUMENTS**

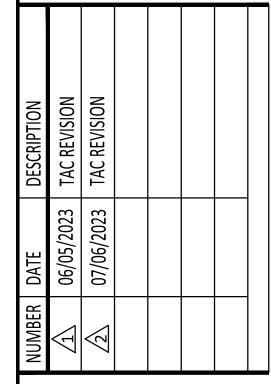

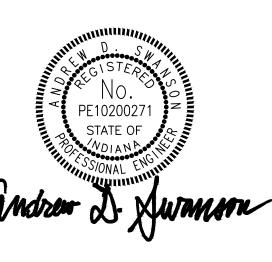

OVERALL STORMWATER POLLUTION PREVENTION PI AN

<u> PLAN</u>	
SCALE:	1" = 30'
DATE:	MAY 31, 2023
PROJECT #:	22JPSC83
DRAWN:	CLM

COORD: ADS

APPROVED: ADS

STORMWATER POLLUTION PREVENTION MAINTENANCE NOTES

- SILT FENCE: INSPECT SILT FENCE WEEKLY AND AFTER EACH STORM EVENT. IF FENCE FABRIC TEARS, STARTS TO DECOMPOSE, OR IN ANY WAY BECOMES INEFFECTIVE, REPLACE THE AFFECTED PORTION IMMEDIATELY. REMOVE DEPOSITED SEDIMENT WHEN IT REACHES HALF THE HEIGHT OF THE FENCE AT ITS LOWEST POINT OR IS CAUSING THE FABRIC TO BULGE. TAKE CARE TO AVOID UNDERMINING THE FENCE DURING CLEANOUT. AFTER THE CONTRIBUTING DRAINAGE AREA HAS BEEN STABILIZED, REMOVE THE FENCE AND SEDIMENT DEPOSITS, BRING THE DISTURBED AREA TO GRADE AND
- CATCH BASIN FILTER: INSPECT WEEKLY AND AFTER EACH STORM EVENT. REMOVE BUILT-UP SEDIMENT AND REPLACE THE GEOTEXTILE FABRIC AFTER EACH STORM EVENT. PERIODICALLY REMOVE SEDIMENT AND TRACKED ON SOIL FROM THE STREET (BUT NOT BY FLUSHING WITH WATER) TO REDUCE THE SEDIMENT LOAD ON THIS CURB INLET PRACTICE.
- EROSION CONTROL BLANKETS: DURING VEGETATIVE ESTABLISHMENT, INSPECT AFTER STORM EVENTS FOR ANY EROSION BELOW THE BLANKET. IF ANY AREA SHOWS EROSION, PULL BACK THAT PORTION OF THE BLANKET COVERING IT, ADD SOIL, RE-SEED THE AREA, RE-LAY AND STAPLE THE BLANKET. CHECK THE TREATED AREAS PERIODICALLY.
- STONE CONSTRUCTION ENTRANCE: INSPECT ENTRANCE PAD AND SEDIMENT DISPOSAL AREA WEEKLY AND AFTER STORM EVENTS OR HEAVY USE. RESHAPE PAD AS NEEDED FOR DRAINAGE AND RUNOFF CONTROL. TOP DRESS WITH CLEAN STONE AS NEEDED. IMMEDIATELY REMOVE MUD AND SEDIMENT TRACKED OR WASHED ONTO PUBLIC ROADS BY BRUSHING OR SWEEPING. FLUSHING SHOULD ONLY BE USED IF THE WATER IS CONVEYED INTO A SEDIMENT TRAP OR BASIN. REPAIR ANY BROKEN ROAD
- CONCRETE WASHOUT: INSPECT DAILY FOR DAMAGE. REPAIR ANY DAMAGE IMMEDIATELY. MAINTAIN 12" MINIMUM FREEBOARD. CLEAN OR CONSTRUCT NEW WASHOUT ONCE EXISTING

STORMWATER POLLUTION PREVENTION **GENERAL NOTES**

- 1. THE CONTRACTOR SHALL CONTROL WASTE, GARBAGE, DEBRIS, WASTEWATER, AND OTHER SUBSTANCES ON THE SITE IN SUCH A WAY THAT THEY SHALL NOT BE TRANSPORTED FROM THE SITE BY THE ACTION OF WINDS, STORM WATER RUNOFF, OR OTHER FORCES. PROPER DISPOSAL OR MANAGEMENT OF ALL WASTES AND UNUSED BUILDING MATERIAL, APPROPRIATE TO THE NATURE OF THE WASTE OR MATERIAL, IS REQUIRED.
- 2. PUBLIC OR PRIVATE ROADWAY SHALL BE KEPT CLEARED OF ACCUMULATED SEDIMENT. BULK CLEARING OF ACCUMULATED SEDIMENT SHALL NOT INCLUDE FLUSHING THE AREA WITH WATER. CLEARED SEDIMENT SHALL BE RETURNED TO THE POINT OF LIKELY ORIGIN OR OTHER SUITABLE LOCATION.
- 3. THE STORMWATER POLLUTION PREVENTION PLAN SHALL BE IMPLEMENTED ON ALL DISTURBED AREAS. ALL MEASURES INVOLVING POLLUTION PREVENTION PRACTICES SHALL BE INSTALLED UNDER THE GUIDANCE OF QUALIFIED PERSONNEL EXPERIENCED IN POLLUTION PREVENTION, AND FOLLOWING THE PLANS AND SPECIFICATIONS INCLUDED
- 4. ALL STORMWATER POLLUTION PREVENTION PLAN PRACTICES SHALL BE IN ACCORDANCE WITH FEDERAL, STATE AND LOCAL REQUIREMENTS FOR MATERIALS, INSTALLATION AND MAINTENANCE STANDARDS.
- 5. SEED ALL DISTURBED AREAS IMMEDIATELY AFTER GRADING SOIL. REFER TO SPECIFICATIONS FOR SEASONAL REQUIREMENTS AND SOIL PREPARATION.



	SEASONAL SOIL PROTECTION CHART											
STABILIZATION PRACTICE	JAN	FEB	MAR	APR	MAY	JUN	JUL	AUG	SEPT	ОСТ	NOV	DEC
PERMANENT SEEDING *		Α						А				
DORMANT SEEDING **			Α		,			•			А	
TEMPORARY SEEDING		B D						С				

- A = REFER TO SPECIFICATIONS FOR PERMANENT SEEDING MIXTURE. FERTILIZE AS RECOMMENDED BY SOIL TEST, IF TESTING IS NOT DONE, APPLY 400-600 LBS./ACRE OF 12-12-12 ANALYSIS, OR EQUIVALENT, FERTILIZER.
- B = SPRING OATS 3 BUSHELS / ACRE (2.3lbs. / 1000 Sq ft) FERTILIZE AS RECOMMENDED BY SOIL TEST. IF TESTING IS NOT DONE, APPLY 400- 600 LBS./ACRE OF 12-12-12 ANALYSIS, OR EQUIVALENT, FERTILIZER.
- C = WHEAT OR RYE 2 BUSHELS/ACRE (3.5lbs. / 1000 Sq. ft) FERTILIZE AS RECOMMENDED BY SOIL TEST. IF TESTING IS NOT DONE, APPLY 400- 600 LBS./ACRE OF 12-12-12 ANALYSIS, OR EQUIVALENT, FERTILIZER.
- D = ANNUAL RYEGRASS 40 LBS./ACRE (1 LB./1000 SQ. FT.)
- * IRRIGATION NEEDED DURING JUNE, JULY, AUGUST AND SEPTEMBER
- ** INCREASE SEEDING APPLICATION BY 50%

	PLAN				`T
- 1	ONLY	\dashv	SECTION A	IDEM STANDARD PLAN REVIEW CHECKLIS	01
ADEQUATE	DEFICIENT	N/A		A: BASIC PLAN ELEMENTS DESCRIPTION	ITEM INFORMATION / MISCELLANEOUS
Ar	D	z	ITEM A1	PLAN INDEX SHOWING LOCATIONS OF REQUIRED ITEMS	THIS SHEET
\dashv				VICINITY MAP DEPICTING THE PROJECT SITES LOCATION IN RELATIONSHIP TO RECOGNIZABLE LOCAL LANDMARK, CITIES,	
4			A2	TOWNS, MAJOR ROADS, AND RAILWAYS.	PROJECT INFORMATION SHEET
		Н	A3 A4	NARRATIVE DESCRIBING PROJECT NATURE AND PURPOSE LATITUDE AND LONGITUDE TO THE NEAREST (15) SECONDS.	THIS SHEET 39°33'33"N 85°46'57"W
-			A5	LEGAL DESCRIPTION OF THE PROJECT SITE. THE DESCRIPTION MUST BE TO THE NEAREST QUARTER SECTION, TOWNSHIP,	SURVEY SHEET
		H	A6	AND RANGE, AND INCLUDE THE CIVIL TOWNSHIP. (INCLUDE LATITUDE AND LONGITUDE - NOI REQUIREMENT.) PLAT DRAWING SHOWING BUILDING LOT NUMBERS/ BOUNDARIES AND ROAD LAYOUT/NAMES.	SURVEY SHEET
-			Ao	FEAT DRAWING SHOWING BUILDING LOT NOWIBERS/ BOONDANIES AND ROAD EATOUT/NAIVIES.	THIS PROJECT IS NOT LOCATED IN FLOODPLAIN AS INDICATED
			A7	100 YEAR FLOODPLAIN, FLOODWAYS, AND FLOODWAY FRINGES.	ON THE CITY OF SHELBYVILLE, IN FLOOD INSURANCE RATE MAI 18145C0110C DATED11/5/2014.
			A8	LAND USE OF ALL ADJACENT PROPERTIES	PLAN UNIT DEVELOPEMENT
-			A9 A10	IDENTIFICATION OF A U.S. EPA APPROVED OR ESTABLISHED TMDL. NAME(S) OF THE RECEIVING WATER(S)	TMDL REPORT - BIG BLUE RIVER FOR E. COLI. BIG BLUE RIVER
7			A11	IDENTIFICATION OF DISCHARGES TO A WATER ON THE CURRENT 303 (d) LIST OF IMPAIRED WATERS AND POLLUTANT(S) FOR	BIG BLUE RIVER IMPAIRED POLLUTANTS: BACTERIA AND OTHEI
-			A12	WHICH IT IS IMPAIRED. A SOILS MAP OF THE PREDOMINATE SOIL TYPES.	MICROBES. SOIL MAP IS SHOWN ON PROJECT SHEET.
			A13	IDENTIFICATION AND LOCATION OF ALL KNOWN WETLANDS, LAKES, AND WATER COURSES ON OR ADJACENT TO THE PROJECT SITE.	INTELLIPLEX PONDS
-			A14	IDENTIFICATION OF ANY STATE OR FEDERAL WATER QUALITY PERMITS OR AUTHORITIES THAT REQUIRED FOR	N/A
_				CONSTRUCTION ACTIVITIES.	
4		Н	A15	IDENTIFICATION AND DELINEATION OF EXISTING COVER, INCLUDING NATURAL BUFFERS.	SURVEY SHEETS
\dashv		\vdash	A16	EXISTING SITE TOPOGRAPHY AT INTERVAL APPROPRIATE TO INDICATE DRAINAGE PATTERNS. LOCATION(S) WHERE RUN-OFF ENTERS THE PROJECT SITE	SURVEY SHEETS SEE GRADING & DRAINAGE PLAN FOR EXISTING STORM
4			A17	LOCATION(S) WHERE RUN-OFF ENTERS THE PROJECT SITE	SEWERS WHERE RUN-OFF ENTERS THE SITE.
			A18	LOCATION(S) WHERE RUN-OFF DISCHARGES FROM THE PROJECT SITE PRIOR TO LAND DISTURBANCE.	STORMWATER DRAINAGE FROM THE SITE WILL BE CONVEYED VIA STORM PIPE INTO THE DETENTION POND.
			A19	LOCATION OF ALL EXISTING STRUCTURES ON THE PROJECT SITE. REFER TO THE EXISTING CONDITIONS PLAN OR TOPOGRAPHIC SURVEY	SURVEY SHEET
			A20	EXISTING PERMANENT RETENTION OR DETENTION FACILITIES , INCLUDING MANMADE WETLAND, DESIGNED FOR THE PURPOSE OF STORM WATER MANAGEMENT	SURVEY SHEETS
			A21	LOCATIONS WHERE STORM WATER MAY BE DIRECTLY DISCHARGED INTO GROUND WATER. SUCH AS ABANDONED WELL, SINKHOLES, OR KARST FEATURES.	THE POND DETENTION BASIN WILL ALLOW FOR SOME WATER DISCHARGE INTO GROUND.
1			A22	SIZE OF THE PROJECT AREA EXPRESSED IN ACRES	4.18 ACRES
_			A23	TOTAL EXPECTED LAND DISTURBANCE EXPRESSED IN ACRES	4.18 ACRES
_			A24	PROPOSED FINAL TOPOGRAPHY.	SEE SITE GRADING AND DRAINAGE PLAN
4			A25	LOCATIONS AND APPROXIMATE BOUNDARIES OF ALL DISTURBED AREAS. LOCATION, SIZE, AND DIMENSIONS OF ALL STORM WATER DRAINAGE SYSTEM SUCH AS CULVERTS, STORMWATER SEWER,	SEE STORMWATER POLLUTION PREVENTION PLAN
			A26	AND CONVEYANCE CHANNELS. LOCATIONS OF SPECIFIC POINTS WHERE STORM WATER AND NON-STORM WATER DISCHARGES WILL LEAVE THE PROJECT	SEE SITE GRADING AND DRAINAGE PLAN
_			A27	SITE. LOCATION OF ALL PROPOSED SITE IMPROVEMENTS, INCLUDING ROADS, UTILITIES, LOT DELINEATION AND IDENTIFICATION,	SEE SITE GRADING AND DRAINAGE PLAN
			A28	PROPOSED STRUCTURES, AND COMMON AREAS LOCATION OF ALL ON-SITE AND OFF-SITE SOIL STOCKPILES AND BORROW AREAS. EXCESS SOIL IT TO BE IMMEDIATELY STOCK	SEE SITE IMPROVEMENT & SITE UTILITY PLANS
			A29	PILED, SURROUNDED WITH SILT FENCE, AND SEEDED WHERE INDICATED IN GRADING PLAN.	REFER TO EROSION CONTROL PLAN
			A30	CONSTRUCTION SUPPORT ACTIVITIES THAT ARE EXPECTED TO BE PART OF THE PROJECT. LOCATION OF ANY IN-STREAM ACTIVITIES THAT ARE PLANNED FOR THIS PROJECT INCLUDING, BUT NOT LIMITED TO ,STREAM CONSTRUCTION OF ANY DELIVERY AND DELIVE	REFER TO EROSION CONTROL PLAN
	_		A31	CROSSINGS AND PUMP AROUND.	N/A
	DEFICIENT	N/A	ITEM	B: ACTIVE CONSTRUCTION COMPONENT DESCRIPTION	ITEM INFORMATION / MISCELLANEOUS
-		z	ITEIVI	A DESCRIPTION OF POTENTIAL POLLUTANT SOURCES ASSOCIATED WITH CONSTRUCTION ACTIVITIES, WHICH MAY	POTENTIAL POST CONSTRUCTION POLLUTANTS TO INCLUDE
			B1	REASONABLY BE EXPECTED TO ADD A SIGNIFICANT AMOUNT OF POLLUTANTS TO STORM WATER DISCHARGES.	FUEL AND OIL FROM VEHICLES AND TRASH FROM PARKING LOUSERS.
			B2	STABLE CONSTRUCTION ENTRANCE LOCATIONS AND SPECIFICATIONS.	SEE STORMWATER POLLUTION PREVENTION PLAN
			В3	SPECIFICATIONS FOR TEMPORARY AND PERMANENT STABILIZATION	REFER TO PLANS FOR PERMANENT GROUND COVER
			B4	SEDIMENT CONTROL MEASURES FOR CONCENTRATED FLOW AREAS	EROSION CONTROL BLANKETS WILL BE INSTALLED TO CONTRO CONCENTRATED FLOW AREAS.
			B5	SEDIMENT CONTROL MEASURES FOR SHEET FLOW AREAS.	SILT FENCE WILL BE INSTALLED AROUND PERMANENT OF THE SITE TO CONTROL SHEET FLOW. SILT FENCE LOCATIONS ARE
			B6	RUNOFF CONTROL MEASURES	SHOWN ON STORMWATER POLLUTION PLANS. STORMWATER POLLUTION PREVENTION PLANS
			B7	STORM WATER OUTLET PROTECTION MEASURES	PROPOSED STORM WATER TO EXISTING STORM SYSTEM.
_					EROSION CONTROL BLANKETS WILL BE USED ON STEEP SLOPES
4			B8	GRADE STABILIZATION STRUCTURE LOCATIONS	AND SILT FENCE TO CONTROL EROSION. TEMPORARY & PERMANENT SEEDING WILL BE USED FOR
_			B9	DEWATERING APPLICATIONS AND MANAGEMENT METHODS.	STABILIZATION.
-			B10	MEASURES UTILIZED FOR WORK WITHIN WATERBODIES	N/A SEE STROMWATER POLLUTION PREVENTION MAINTENANCE
			B11	MAINTENANCE GUIDELINES FOR EACH PROPOSED STORMWATER QUALITY MEASURE	NOTES AND SPECIFICATION 31-25-00 FOR SELF MONITORING PROCESS.
			B12	SEQUENCE DESCRIBING STORMWATER QUALITY MEASURE IMPLEMENTATION RELATIVE TO LAND-DISTURBING ACTIVITIES	REFER TO STROMWATER POLLUTION PREVENTION PLAN, SEQUENCE SCHEDULE.
			B13	PROVISIONS FOR EROSION AND SEDIMENT CONTROL ON INDIVIDUAL RESIDENTIAL BUILDING LOTS REGULATED UNDER THE PROPOSED PROJECT.	THE SITE IS NOT CURRENTLY SUBDIVIDED, THEREFORE THE ENTIRE SITE IS ON THIS PLAN'S EROSION CONTROL PLAN.
T			B14	MATERIAL HANDLING AND SPILL PREVENTION AND SPILL RESPONSE PLAN MEETING THE REQUIREMENTS IN 327 IAC 2-6.1	SEE STORMWATER POLLUTION PREVENTION MAINTENANCE NOTES AND SPEC SECTION 31-25-00 FOR SELF MONITORING
			B14	INVALENTAL HANDEING AND SEIZE ENEVENTION AND SEIZE RESPONSE FEAR MICE TIME REQUIREMENTS IN 327 FAC 2-0.1	PROCESS. CONTRACTOR SHALL CONTAIN ANY SPILL OF MATERIALS IN
			B15	MATERIAL HANDLING AND STORAGE PROCEDURES ASSOCIATED WITH CONSTRUCTION ACTIVITY	SUCH A MANNER TO PREVENT LEAKAGE INTO A STORM SEWER OR DRAINWAY. CONTACT THE INDIANA DEPARTMENT OF ENVIRONMENTAL MANAGEMENT (IDEM) OFFICE OF LAND QUALITY EMERGENCY RESPONSE SECTION, IDEM 24-HOUR SPILL LINE AT 888-233-7745, OR 317-233-7745 UPON DISCOVERY OF AN ACCIDENT TO DETERMINE IDEM'S INVOLVEMENT AND PROCEDURES FOR CLEANUP.
ACA IL	ENT		SECTION C	: POST CONSTRUCTION COMPONENT	
	DEFICIENT	N/A	ITEM	DESCRIPTION	ITEM INFORMATION / MISCELLANEOUS
			C1	A DESCRIPTION OF POTENTIAL POLLUTANT SOURCES FROM THE PROJECT SITE'S PROPOSED LAND USE, WHICH SOURCES MAY REASONABLY BE EXPECTED TO ADD A SIGNIFICANT AMOUNT OF POLLUTANTS TO STORM WATER DISCHARGES FROM	POTENTIAL POST CONSTRUCTION POLLUTANTS TO INCLUDE FUEL AND OIL FROM VEHICLES AND TRASH FROM PARKING LO
			C2	THE POST-CONSTRUCTION PROJECT SITE. DESCRIPTION OF PROPOSED POST-CONSTRUCTION STOR	USERS. INTELLIPLEX PONDS WILL PROVIDE POST CONSTRUCTION STORMWATER QUALITY.
\exists			C3	PLAN DETAILS FOR EACH STORMWATER MEASURES	INTELLIPLEX PONDS WILL PROVIDE POST CONSTRUCTION
\exists			C4	SEQUENCE DESCRIBING STORM WATER QUALITY MEASURE IMPLEMENTATION	STORMWATER QUALITY. REFER TO 2003 INTELLIPLEX DRAINAGE REPORT.
			C5	DESCRIPTION OF MAINTENANCE GUIDELINES FOR POST-CONSTRUCTION STORM WATER QUALITY MEASURES	REFER TO 2003 INTELLIPLEX DRAINAGE REPORT.
			C6	ENTITY THAT WILL BE RESPONSIBLE FOR OPERATION AND MAINTENANCE OF THE POST -CONSTRUCTION STORMWATER MEASURES	MAJOR HEALTH PARTNERS.

PROJECT NARRATIVE

CONSTRUCTION OF A NEW FREE STANDING, DAY CARE FACILITY AND ASSOCIATED PRIVATE DRIVE

RESPONSIBLE PERSON

KRISTOPHER LASURE PROJECT MANAGER/ESTIMATOR RUNNEBOHM CONSTRUCTION 144 EAST RAMPART STREET, SHELBYVILLE, INDIANA 46176 317.716.0163

STORMWATER POLLUTION PREVENTION PLAN -CONSTRUCTION COMPONENT

CONSTRUCTION SEQUENCE SCHEDULE

1. DESCRIPTION OF POTENTIAL POLLUTANT SOURCES ASSOCIATED WITH CONSTRUCTION POTENTIAL POLLUTION SOURCES ASSOCIATED WITH CONSTRUCTION ACTIVITY INCLUDE: SEDIMENT IN RUNOFF FROM EXPOSED SOILS, RUNOFF FROM CONSTRUCTION MATERIAL STORAGE, AND SPILLAGE FROM CONSTRUCTION EQUIPMENT AND REFUELING SITES. CONTRACTOR SHALL CONTAIN ALL SEDIMENT BY PROPER EROSION CONTROL PRACTICES AS INDICATED IN THE STORM WATER POLLUTION PREVENTION PLAN. CONTRACTOR SHALL CONTROL POLLUTION FROM MATERIAL STORAGE BY PROPER STORAGE PROCEDURES. MATERIALS THAT ARE A POTENTIAL SOURCE OF POLLUTION SHALL BE STORED IN CONTAINERS PROTECTED FROM ELEMENTS. OR IN THE JOB TRAILER, POLLUTION FROM REFUELING SHALL BE PREVENTED BY PROPER REFUELING PRACTICES. PROPER CONTAINMENT AND CLEANUP SHALL BE EMPLOYED IF A SPILL OCCUR

2. SEQUENCE DESCRIBING STORMWATER QUALITY MEASURES IMPLEMENTATION RELATIVE TO

LAND DISTURBING ACTIVITIES. CONSTRUCTION PHASE (SPECIFIC ACTIVITIES OR CONSTRUCTION OPERATIONS **EROSION CONTROL PRACTICES)*** PRE-CONSTRUCTION ACTIONS BEFORE CONSTRUCTION, EVALUATE, MARK, AND (EVALUATION/PROTECTION OF PROTECT IMPORTANT TREES AND ASSOCIATED IMPORTANT SITE CHARACTERISTICS) ROOTING ZONES, UNIQUE AREAS (E.G. WETLANDS) TO BE PRESERVED, ON-SITE SEPTIC SYSTEM ABSORPTION FIELDS, AND VEGETATION SUITABLE FOR FILTER STRIPS, ESPECIALLY IN PERIMETER AREAS LAND CLEARING AND GRADING BEGIN MAJOR CLEARING AND GRADING AFTER (CUTTING/FILLING/STOCKPILING, GRADING,

DRAINS, SEDIMENT TRAPS, BARRIERS,

DIVERSIONS, SURFACE ROUGHENING)

BUILDING CONSTRUCTION (BUILDINGS, UTILITIES, LANDSCAPING AND FINAL STABILIZATION (TOP SOILING, TREES AND SHRUBS, PERMANENT AND SPOIL AREAS. SEEDING, MULCHING, SODDING, RIP RAP)

MEASURES AS GRADING PROGRESSES AND AROUND INSTALL NECESSARY EROSION AND SEDIMENT CONTROL PRACTICES AS WORK TAKES PLACE. STABILIZE ALL OPEN AREAS, INCLUDING BORROW

REMOVE TEMPORARY CONTROL MEASURES AND

POSSIBLE. INSTALL PRINCIPAL CONVEYANCE SYSTEM

CONTROL MEASURES DURING GRADING AS NEEDED.

WITH RUNOFF CONTROL MEASURES. INSTALL

INSTALLING THE KEY SEDIMENT AND RUNOFF

AS NEEDED. INSTALL ADDITIONAL CONTROL

MEASURES. CLEAR BORROW AND DISPOSAL AREAS

3. STABILIZE CONSTRUCTION ENTRANCE LOCATIONS AND SPECIFICATIONS (AT ALL POINTS OF

STABILIZE.

INGRESS AND EGRESS) CONSTRUCTION PHASE (SPECIFIC ACTIVITIES OR CONSTRUCTION OPERATIONS EROSION CONTROL PRACTICES)* STABILIZE BARE AREAS IMMEDIATELY WITH GRAVEL AND TEMPORARY VEGETATION AS WORK TAKES (CONSTRUCTION ENTRANCES, CONSTRUCTION PLACE. (UTILIZE EXISTING PAVEMENT SURFACES ROUTES, EQUIPMENT PARKING AREAS) THROUGHOUT CONSTRUCTION) 4. SEDIMENT CONTROL MEASURES FOR SHEET FLOW AREAS CONSTRUCTION PHASE (SPECIFIC ACTIVITIES OR CONSTRUCTION OPERATIONS **EROSION CONTROL PRACTICES)*** APPLY TEMPORARY OR PERMANENT STABILIZATION SURFACE STABILIZATION (TEMPORARY AND MEASURES IMMEDIATELY ON ALL DISTURBED AREAS PERMANENT SEEDING, MULCHING, WHERE WORK IS DELAYED OR COMPLETED. (NO AREA SODDING, RIP RAP) IS TO BE LEFT UNCOVERED MORE THAN 5 DAYS.) 5 SEDIMENT CONTROL MEASURES FOR CONCENTRATED FLOW AREAS CONSTRUCTION PHASE (SPECIFIC ACTIVITIES OR CONSTRUCTION OPERATIONS **EROSION CONTROL PRACTICES)*** STORMWATER CONVEYANCE SYSTEM WHERE NECESSARY, STABILIZE SWALES AS EARLY AS

REMAINDER OF SYSTEM AFTER GRADING. 6. STORM SEWER INLET PROTECTION MEASURE LOCATIONS AND SPECIFICATIONS

REFER TO STORMWATER POLLUTION PREVENTION PLAN AND INLET STRUCTURE FILTER DETAIL

7. RUNOFF CONTROL MEASURES (E.G. DIVERSIONS, ROCK CHECK DAMS, SLOPE DRAINS, ETC.)

8. STORMWATER OUTLET PROTECTION SPECIFICATIONS CONSTRUCTION PHASE (SPECIFIC ACTIVITIES OR EROSION CONTROL PRACTICES)*

(STABILIZED SWALES, STORM DRAINS,

INLET AND OUTLET PROTECTION)

PROTECTION)

CONSTRUCTION OPERATIONS RUNOFF CONTROL (DIVERSIONS, INSTALL PRACTICES AFTER PRINCIPAL SEDIMENT PERIMETER DITCHES, DAMS, OUTLET TRAPS AND BARRIERS ARE INSTALLED BUT BEFORE LAND GRADING. INSTALL ADDITIONAL RUNOFF

9. GRADE STABILIZATION STRUCTURE LOCATIONS AND SPECIFICATIONS CONSTRUCTION PHASE (SPECIFIC ACTIVITIES OR CONSTRUCTION OPERATIONS EROSION CONTROL PRACTICES)* SEDIMENT BARRIERS AND TRAPS (BASIN TRAPS, SILT FENCES, OUTLET PROTECTION) INSTALL PRINCIPAL BASINS AFTER CONSTRUCTION SITE IS ASSESSED. INSTALL ADDITIONAL TRAPS AND BARRIERS AS NEEDED DURING GRADING.

10.LOCATION, DIMENSIONS, SPECIFICATIONS AND CONSTRUCTION DETAILS OF EACH STORM WATER QUALITY MEASURE REFER TO STORMWATER POLLUTION PREVENTION PLAN AND DETAILS

11.TEMPORARY SURFACE STABILIZATION METHODS APPROPRIATE FOR EACH SEASON

(INCLUDE SEQUENCING) 12.PERMANENT SURFACE STABILIZATION SPECIFICATIONS (INCLUDE SEQUENCING)

REFER TO SEASONAL SOIL PROTECTION CHART 13.MATERIAL HANDLING AND SPILL PREVENTION PLAN

CONTRACTOR SHALL CONTAIN ANY SPILL OF MATERIALS IN SUCH A MANNER TO PREVENT LEAKAGE INTO A STORM SEWER OR DRAINWAY. CONTACT THE INDIANA DEPARTMENT OF ENVIRONMENTAL MANAGEMENT (IDEM) OFFICE OF LAND QUALITY EMERGENCY RESPONSE SECTION, IDEM 24-HOUR SPILL LINE AT 888-233-7745, OR 317-233-7745 UPON DISCOVERY OF AN ACCIDENT TO DETERMINE IDEM'S INVOLVEMENT AND PROCEDURES FOR CLEANUP.


14.MONITORING AND MAINTENANCE GUIDELINES FOR EACH PROPOSED STORMWATER QUALITY MEASURE.


MONITORING AND MAINTENANCE: (1) INSPECT PRACTICES AND REPAIR AS REQUIRED AT LEAST ONCE A WEEK, & (2) WITHIN 24 HOURS OF EVERY 1/2" RAIN EVENT

15. SOIL STOCKPILE AND STAGING AREA

ALL DISTURBED GROUND SHALL NOT BE LEFT IDLE FOR MORE THAN 2 WEEKS WITHOUT SEEDING FOR STABILIZATION. SOIL STOCKPILES SHALL BE SURROUNDED WITH SILT FENCE AND SEEDED IF NOT USED WITHIN 2 WEEKS.

CONSTRUCTION **DOCUMENTS**

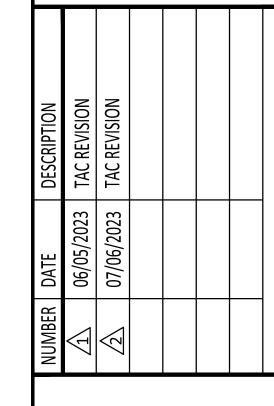


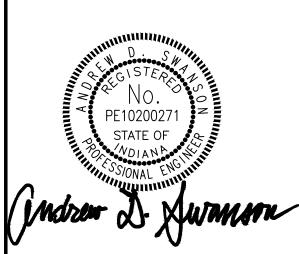

POLLUTION PREVENTION

SCALE: AS NOTED MAY 31, 2023 PROJECT #: 22JPSC83 DRAWN: CLM

COORD: ADS

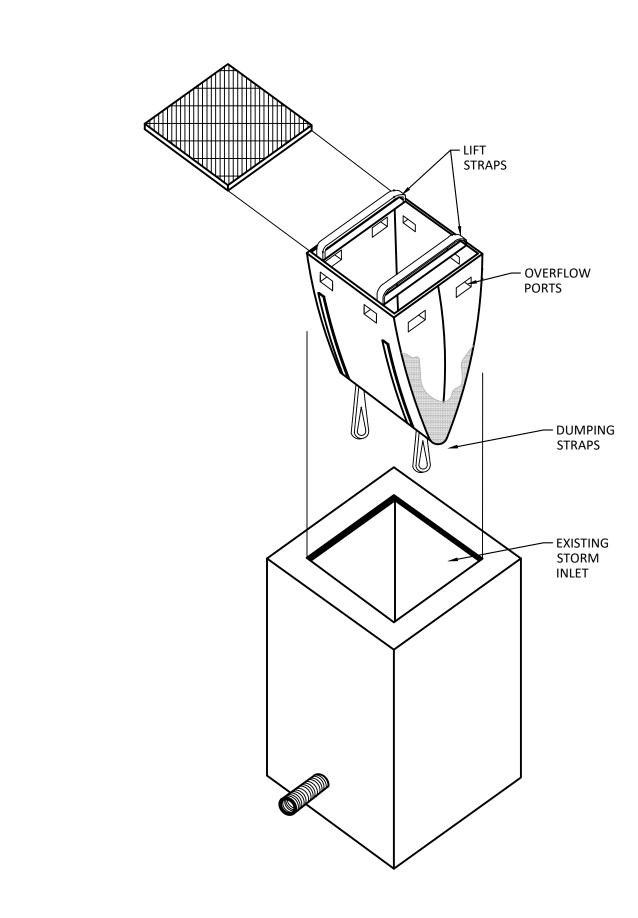


REMOVE THE GRATE FROM THE INLET AND STAND ON END. MOVE THE TOP BY LIFTING STRAP OUT OF THE WAY AND PLACE THE GRATE INTO THE UNIT SO THAT THE GRATE IS BELOW THE TOP STRAPS AND ABOVE


INSERT THE GRATE INTO THE INLET UTILIZING THE LIFTING DEVICES.

REMOVE ALL ACCUMULATED SEDIMENT AND DEBRIS FROM AROUND THE UNIT FOLLOWING EACH STORM EVENT. LOOK INTO THE UNIT FOLLOWING EACH STORM EVENT AND AT REGULAR INTERVALS. THE UNIT MUST BE EMPTIED IF IT IS MORE THAN 1/3 FULL OF ACCUMULATED SEDIMENT. EMPTY THE UNIT BY USING THE LIFTING STRAPS TO LIFT IT OUT OF THE INLET AND REMOVE THE GRATE. TRANSPORT THE UNIT TO AN APPROPRIATE LOCATION TO REMOVE CONTENTS. UTILIZING THE DUMPING STRAPS ON THE OUTSIDE AT THE BOTTOM OF THE UNIT, TURN THE UNIT UPSIDE DOWN, EMPTYING THE CONTENTS. REINSTALL THE

CURB INLET PROTECTION SHALL BE DANDY SACK OR APPROVED EQUAL

INLET PROTECTION DETAIL

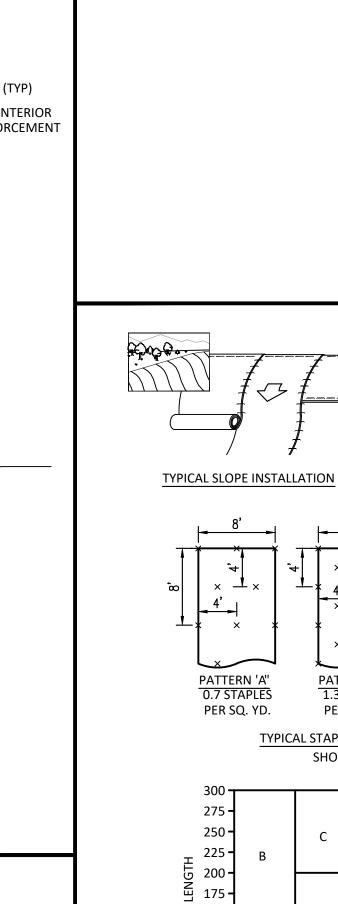


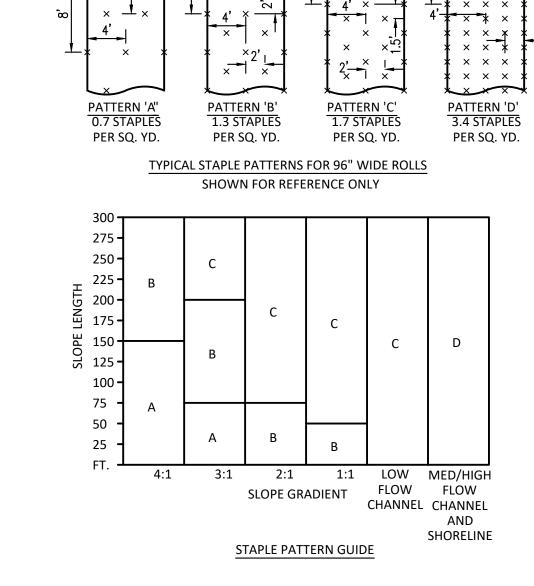

TYPICAL CHANNEL INSTALLATION

INSTALL TEMPORARY AND PERMANENT SEDIMENT AND EROSION CONTROL PRACTICES IMMEDIATELY AFTER LAND DISTURBING ACTIVITIES. GRADE SITE PER GRADING PLANS. PREPARE AND PLACE TOPSOIL PER SPECIFICATIONS. REFER TO EROSION CONTROL BLANKET MANUFACTURER'S RECOMMENDATIONS FOR INSTALLATION (ANCHORAGE, STAPLE PATTERN/SPACING, SPLICING, ETC.).



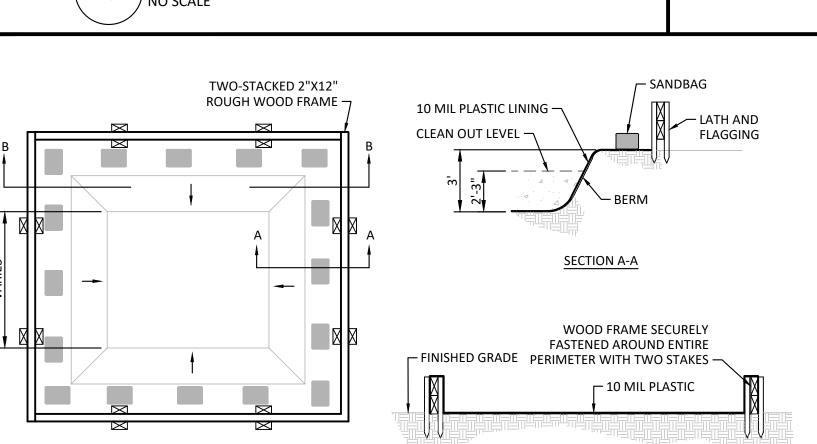

PORTLAND CEMENT CONCRETE WASTE SHALL NOT BE ALLOWED TO ENTER STORM DRAINS OR WATERCOURSES.

TEMPORARY CONCRETE WASHOUT FACILITIES SHALL BE LOCATED AT LEAST 50 FEET FROM OPEN DRAINAGE FACILITIES AND WATERCOURSES. EACH FACILITY SHALL BE LOCATED AWAY FROM CONSTRUCTION TRAFFIC OR ACCESS AREAS TO PREVENT DISTURBANCE OR TRACKING.

PERFORM WASHOUT OF MIX TRUCK CHUTES IN DESIGNATED AREAS ONLY. HOLES, DEPRESSIONS OR OTHER GROUND DISTURBANCE CAUSED BY THE REMOVAL OF THE TEMPORARY CONCRETE WASHOUT FACILITY SHALL BE RESTORED TO ORIGINAL GROUND WITH BERM AND SIMILAR SOIL MATERIALS. TEMPORARY CONCRETE WASHOUT FACILITIES SHALL BE MAINTAINED TO PROVIDE ADEQUATE HOLDING CAPACITY WITH A MINIMUM FREEBOARD OF 12 INCHES. MAINTAINING TEMPORARY WASHOUT FACILITIES SHALL INCLUDE REMOVING AND LEGALLY DISPOSING OF HARDENED CONCRETE AND RETURNING THE FACILITY TO A FUNCTIONAL CONDITION.

EXISTING FACILITIES MUST BE CLEANED, OR NEW FACILITIES CONSTRUCTED AND READY FOR USE ONCE THE WASHOUT IS 75% FULL. TEMPORARY CONCRETE WASHOUT FACILITIES SHALL BE INSPECTED DAILY FOR DAMAGE (TEARS IN THE LINER, MISSING SANDBAGS, ETC.). DAMAGED

FACILITIES SHALL BE REPAIRED BEFORE FURTHER USE. CONTRACTOR TO INSTALL TEMPORARY SIGNAGE OF SUFFICIENT MATERIALS TO INDICATE THE LOCATION OF THE WASHOUT AREA TO MIX TRUCK DRIVERS.

CONCRETE WASHOUT AREA DETAIL
NO SCALE

SECTION B-B

6" MIN #2 STONE—

PROFILE

100' MIN

<u>PLAN</u>

- GEOTEXTILE FABRIC

2.0%

CONSTRUCTION ENTRANCE DETAIL

— NON-WOVEN FILTER FABRIC

SEDIMENT SEDIMENT-LADEN

- ACCUMULATED

COMPACTED FILL

INSTALL TEMPORARY AND PERMANENT SEDIMENT AND EROSION CONTROL

REFER TO SPECIFICATIONS FOR SILT FENCE INFORMATION. INSTALL AND

SILT FENCE DETAIL
NO SCALE

PRACTICES PRIOR TO COMMENCING LAND DISTURBING ACTIVITIES.

MAINTAIN PER MANUFACTURER'S RECOMMENDATIONS.

SLOPE SLOPE 1.0% 2.0%

FILTERED

WATER

EXTEND STAKES 18"

BELOW GRADE

CONTRACTOR SHALL ACQUIRE ALL

PERMITS AND APPROVAL FROM AGENCY

HAVING JURISDICTION OF ROADWAY. RESHAPE PAD AS NEEDED FOR RUNOFF CONTROL. TOP DRESS WITH CLEAN

STONE AS NEEDED. INSPECT WEEKLY.

SEDIMENT TRACKED OR WASHED ON TO

INSTALL TEMPORARY CULVERT PIPE IF REQUIRED TO MAINTAIN EXISTING

IMMEDIATELY REMOVE MUD AND

REPAIR DAMAGE TO EXISTING

PAVEMENT IMMEDIATELY.


EXISTING ROADWAY.


RUNOFF PATTERNS.

VEER

 \mathcal{C}

CONSTRUCTION **DOCUMENTS**

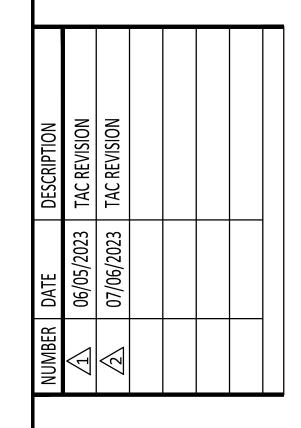


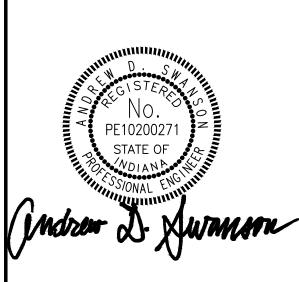

STORMWATER POLLUTION PREVENTION DETAILS

SCALE: AS NOTED MAY 31, 2023 PROJECT #: 22JPSC83 DRAWN: CLM COORD: ADS

APPROVED: ADS

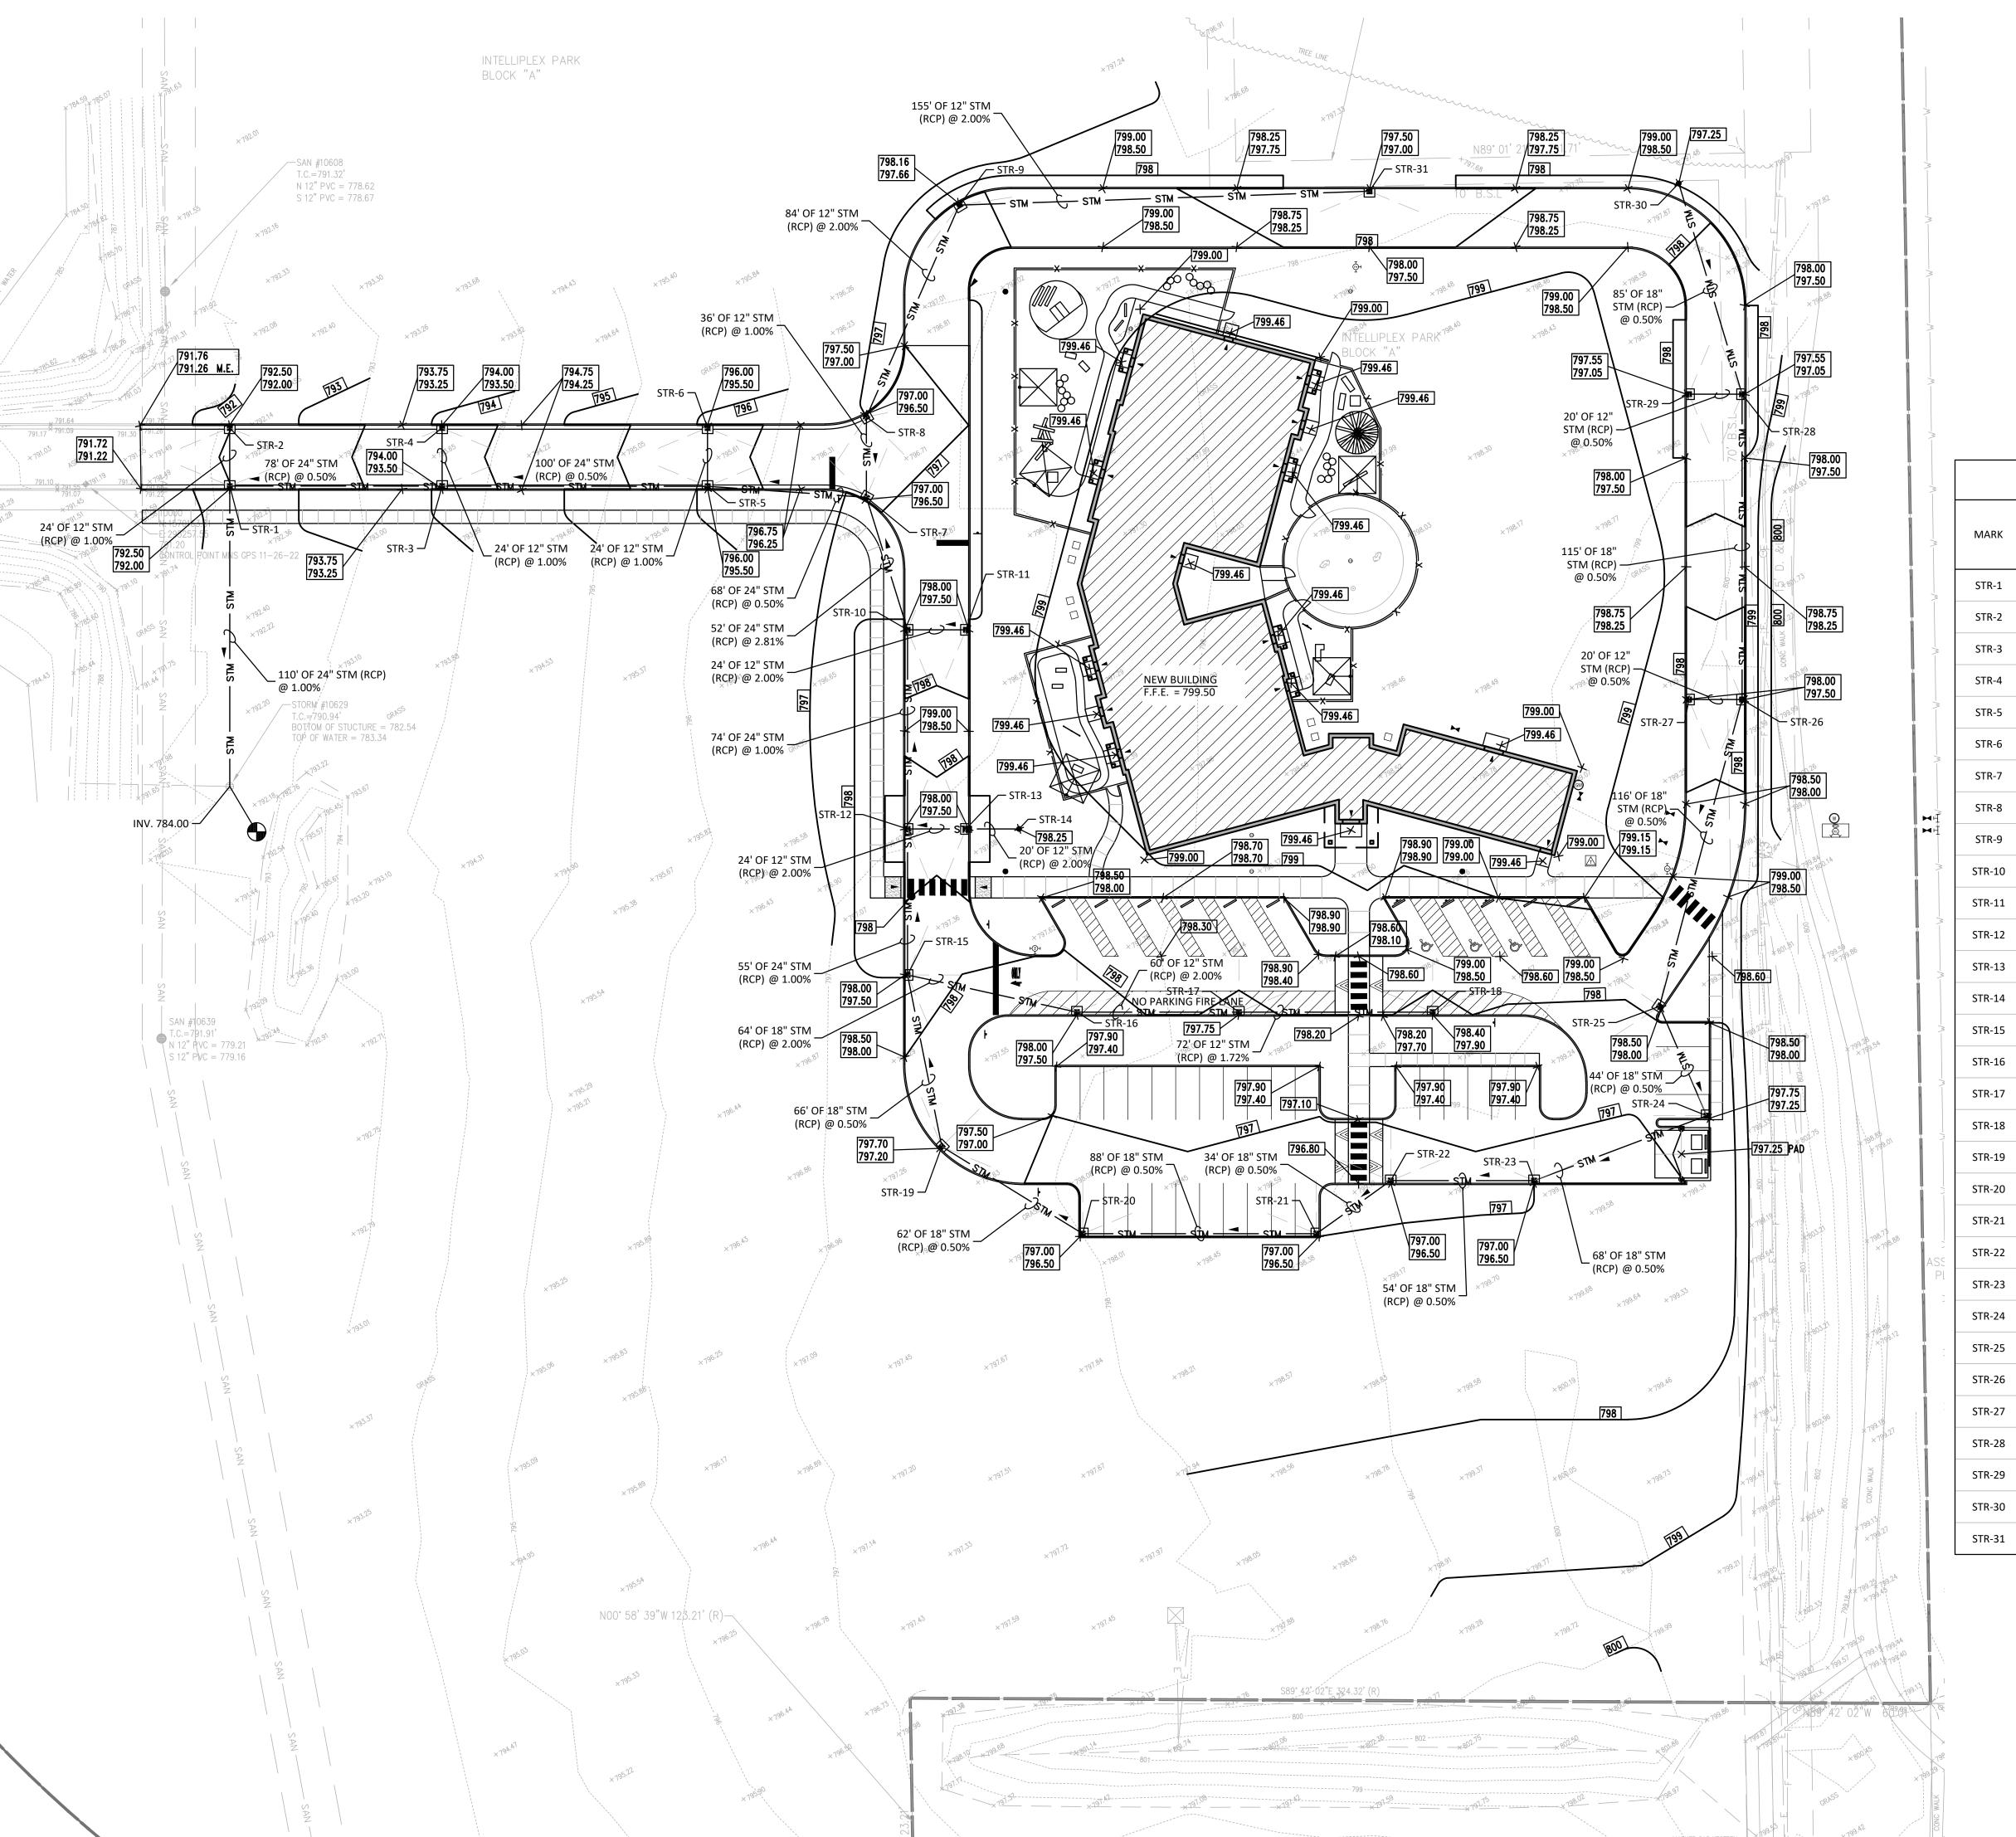

GENERAL NOTES

SYSTEM AT ALL TIMES.

- A. THE CONTRACTOR SHALL BE RESPONSIBLE FOR OBTAINING, AND VERIFYING, THAT ALL PERMITS AND APPROVALS ARE OBTAINED FROM THE RESPECTIVE CITY, COUNTY, STATE AND FEDERAL AGENCIES PRIOR TO STARTING CONSTRUCTION.
- CONTRACTOR SHALL VERIFY LOCATION AND INVERT ELEVATIONS OF EXISTING SEWERS PRIOR TO START OF CONSTRUCTION.
- CONTRACTOR SHALL MAINTAIN A COMPLETE AND OPERABLE UTILITY
- CONTRACTOR SHALL INCLUDE COSTS FOR CUTTING AND PATCHING AS REQUIRED IN THEIR BID PROPOSAL TO COMPLETELY INSTALL THE WORK INDICATED.
- E. CONTRACTOR SHALL INCLUDE ALL TAP FEES, PERMIT FEES AND APPLICATION FEES IN THEIR BID PROPOSAL AS NECESSARY TO COMPLETELY INSTALL THE WORK INDICATED.
- . INFORMATION SHOWN WAS OBTAINED FROM AN OWNER FURNISHED SITE SURVEY OF EXISTING CONDITIONS AND IS UNCONFIRMED. CONTRACTOR IS REQUIRED TO FIELD VERIFY THIS INFORMATION AND NOTIFY ARCHITECT OF ANY DISCREPANCIES SO MODIFICATION CAN BE MADE.
- G. CONTRACTOR SHALL COORDINATE EXACT UTILITY LOCATIONS WITH THE OWNER AND LOCAL UTILITY COMPANIES PRIOR TO COMMENCING ANY WORK. UTILIZE THE INDIANA UNDERGROUND UTILITY LOCATION SERVICE AT 811 OR 800-382-5544 PRIOR TO ANY EXCAVATION ON THE SITE.

STRUCTURE SCHEDULE

>	STRUCTURE SCHEDULE											
		INVE	RT	CAS	TING	STRUCTURE						
*	MARK	INLET	OUTLET	ELEVATION	TYPE	TYPE	DETAIL					
>	STR-1	E 785.10 N 786.10	785.10	792.00	R 3286-8V	STORM MANHOLE	C310					
	STR-2	-	786.34	792.00	R 3286-8V	STORM MANHOLE	C310					
X	STR-3	E 785.49 N 786.49	785.49	793.50	R 3286-8V	STORM MANHOLE	C310					
	STR-4	-	786.73	793.50	R 3286-8V	STORM MANHOLE	C310					
<u> </u>	STR-5	E 785.99 N 786.99	785.99	795.50	R 3286-8V	STORM MANHOLE	C310					
<u></u>	STR-6	-	787.23	795.50	R 3286-8V	STORM MANHOLE	C310					
	STR-7	E 786.33 N 787.33	786.33	796.50	R 3286-8V	STORM MANHOLE	C310					
	STR-8	788.15	787.69	796.50	R 3286-8V	STORM MANHOLE	C310					
⋈ ∄	STR-9	789.83	789.83	797.66	R 2560-E	STORM MANHOLE	C310					
	STR-10	E 788.79 S 787.79	787.79	797.50	R 3286-8V	STORM MANHOLE	C310					
	STR-11	-	789.27	797.50	R 3286-8V	STORM MANHOLE	C310					
	STR-12	E 789.53 S 788.53	788.53	797.50	R 3286-8V	STORM MANHOLE	C310					
	STR-13	790.01	790.01	797.50	R 3286-8V	STORM MANHOLE	C310					
	STR-14	-	790.41	798.25	R 2560-E	STORM MANHOLE	C310					
	STR-15	E 789.58 S789.08	789.08	797.50	R 3286-8V	STORM MANHOLE	C310					
	STR-16	791.36	790.86	797.50	R 3286-8V	STORM MANHOLE	C310					
	STR-17	792.56	792.56	797.75	R 3286-8V	STORM MANHOLE	C310					
	STR-18	-	793.80	797.80	R 3286-8V	STORM MANHOLE	C310					
	STR-19	789.41	789.41	797.20	R 3286-8V	STORM MANHOLE	C310					
	STR-20	789.72	789.72	796.50	R 3286-8V	STORM MANHOLE	C310					
	STR-21	790.16	790.16	796.50	R 3286-8V	STORM MANHOLE	C310					
ASS	STR-22	790.83	790.33	796.50	R 3286-8V	STORM MANHOLE	C310					
Pl Pl	STR-23	791.11	791.11	796.50	R 3286-8V	STORM MANHOLE	C310					
	STR-24	791.45	791.45	797.25	R 3286-8V	STORM INLET	C310					
;	STR-25	791.76	791.76	798.00	R 3286-8V	STORM INLET	C310					
	STR-26	N 792.34 W 792.84	792.34	797.50	R 3286-8V	STORM INLET	C310					
	STR-27	-	792.94	797.50	R 3286-8V	STORM INLET	C310					
	STR-28	N 792.92 W 793.42	792.92	797.05	R 3286-8V	STORM INLET	C310					
	STR-29	_	793.52	797.05	R 3286-8V	STORM INLET	C310					
ĺ	STR-30	-	793.34	797.25	R 2560-E	STORM INLET	C310					
	STR-31	-	792.93	797.00	R 3286-8V	STORM INLET	C310					






365 Counselors Row, Suite 116 Idianapolis, IN 46240 h 317.617.4270

RUNNEBOHM EARLY

CONSTRUCTION DOCUMENTS

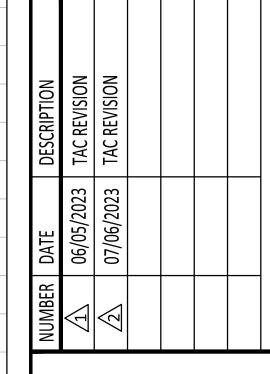





OVERALL SITE GRADING & DRAINAGE PLAN

PLAN	
SCALE:	1" = 30'
DATE:	MAY 31, 2023
PROJECT #:	22JPSC83
DRAWN:	CLM
COORD:	ADS




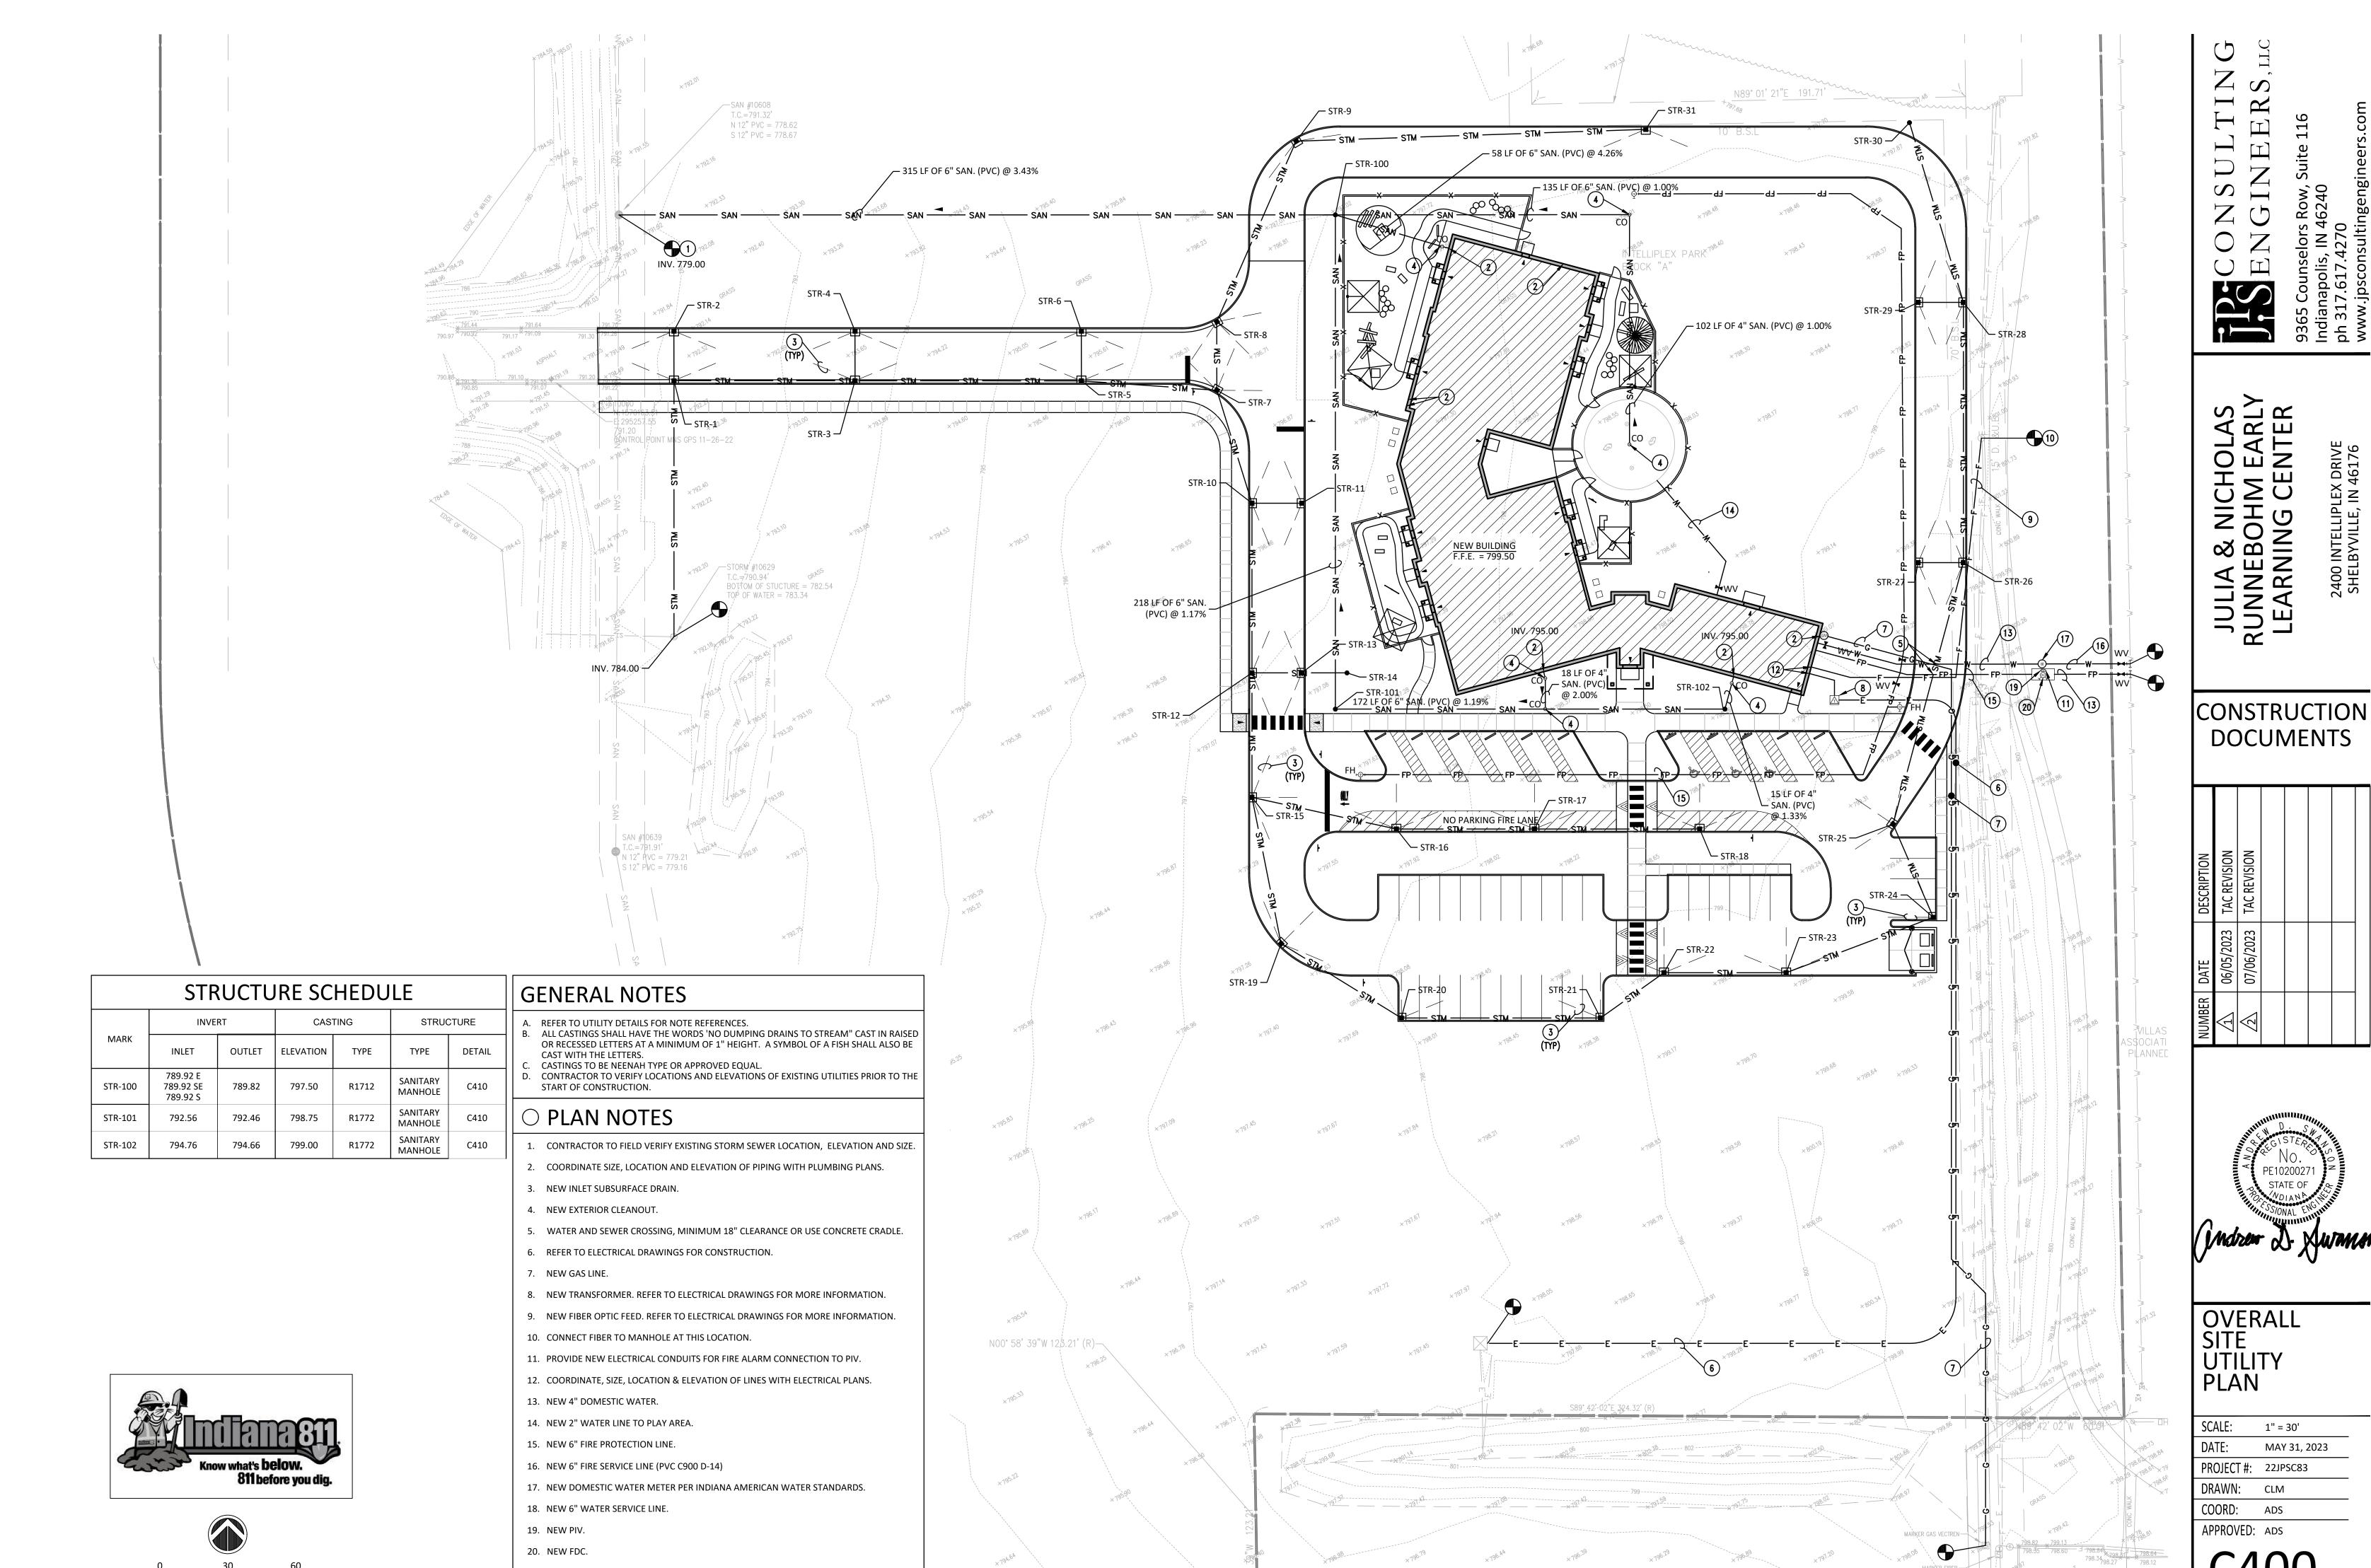



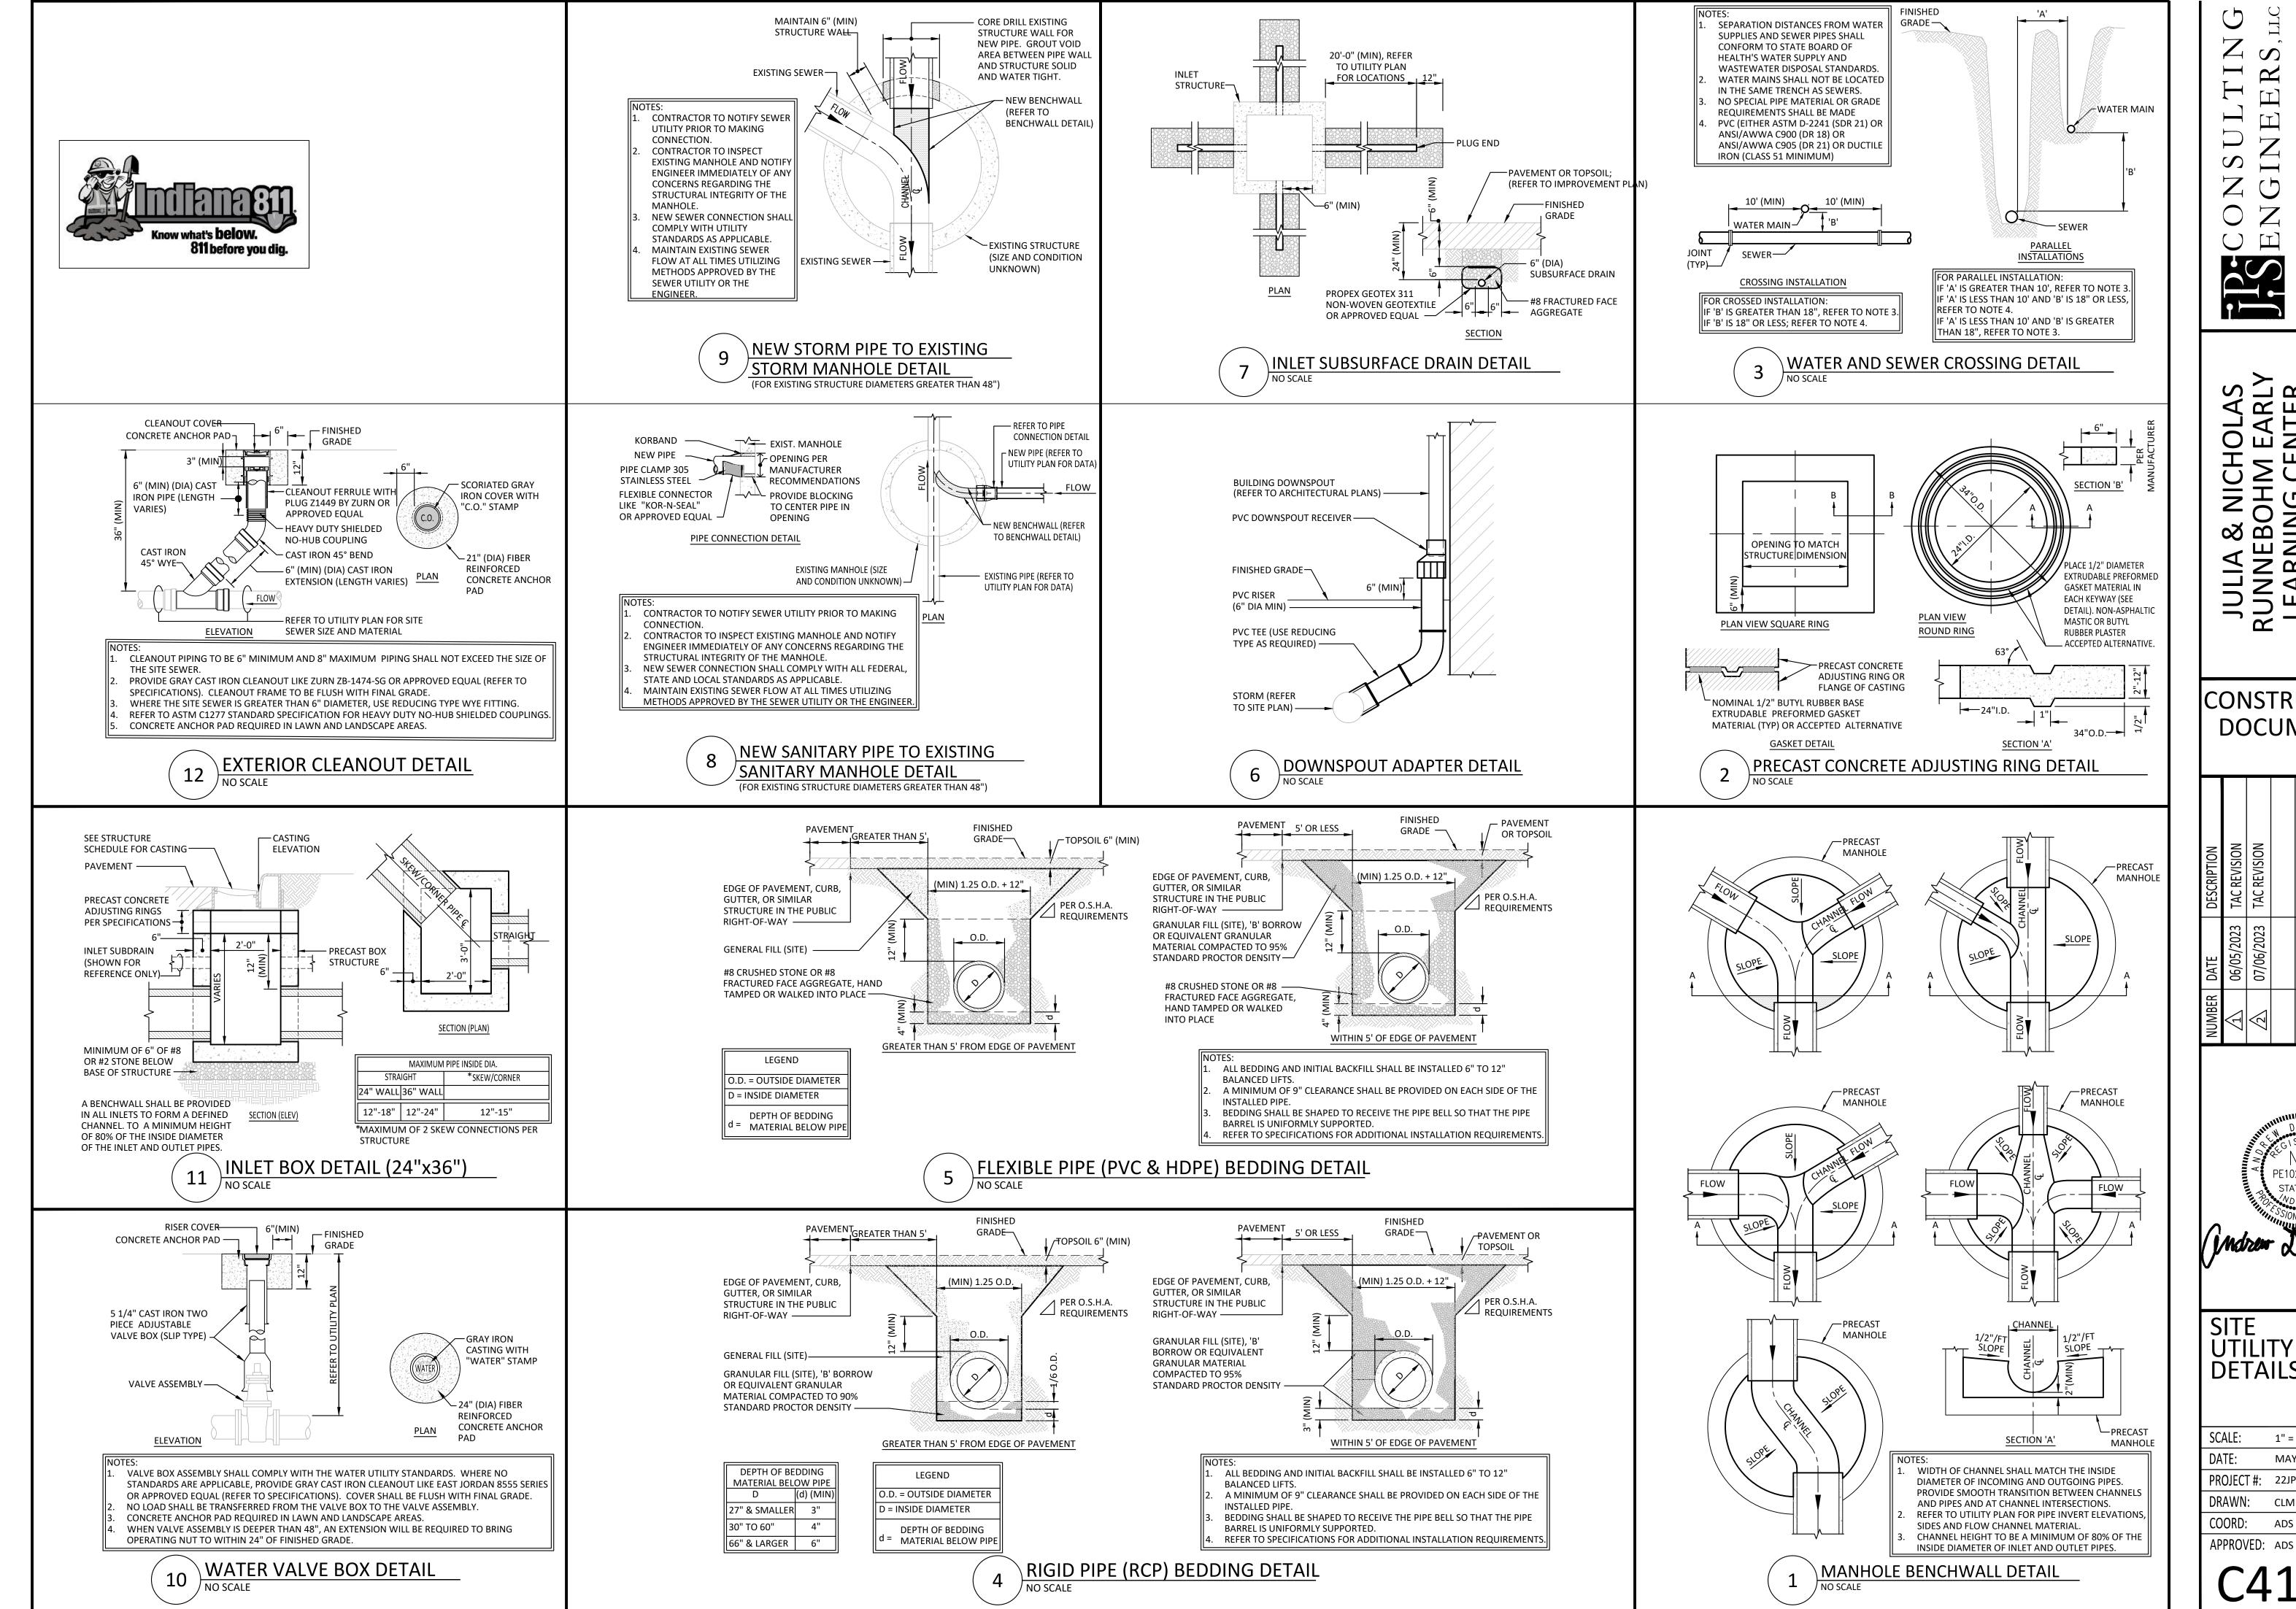

CONSTRUCTION **DOCUMENTS**

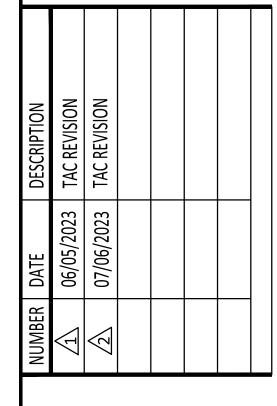



SITE UTILITY DETAILS


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DATE:	MAY 31, 2023
PROJECT #:	22JPSC83
DRAWN:	CLM
COORD:	ADS


CONSULTING ENGINEERS, IL

9365 Counselors R Indianapolis, IN 46 ph 317.617.4270 www.ipsconsulting

RUNNEBOHM EA LEARNING CENT


CONSTRUCTION DOCUMENTS

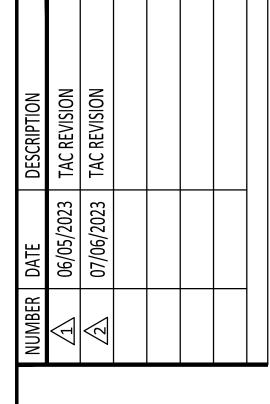

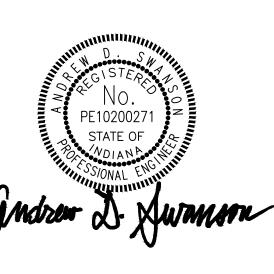

SITE UTILITY DETAILS

SCALE:	1" = 30'
DATE:	MAY 31, 2023
PROJECT #:	22JPSC83
DRAWN:	CLM
COORD:	ADS
APPROVED:	ADS

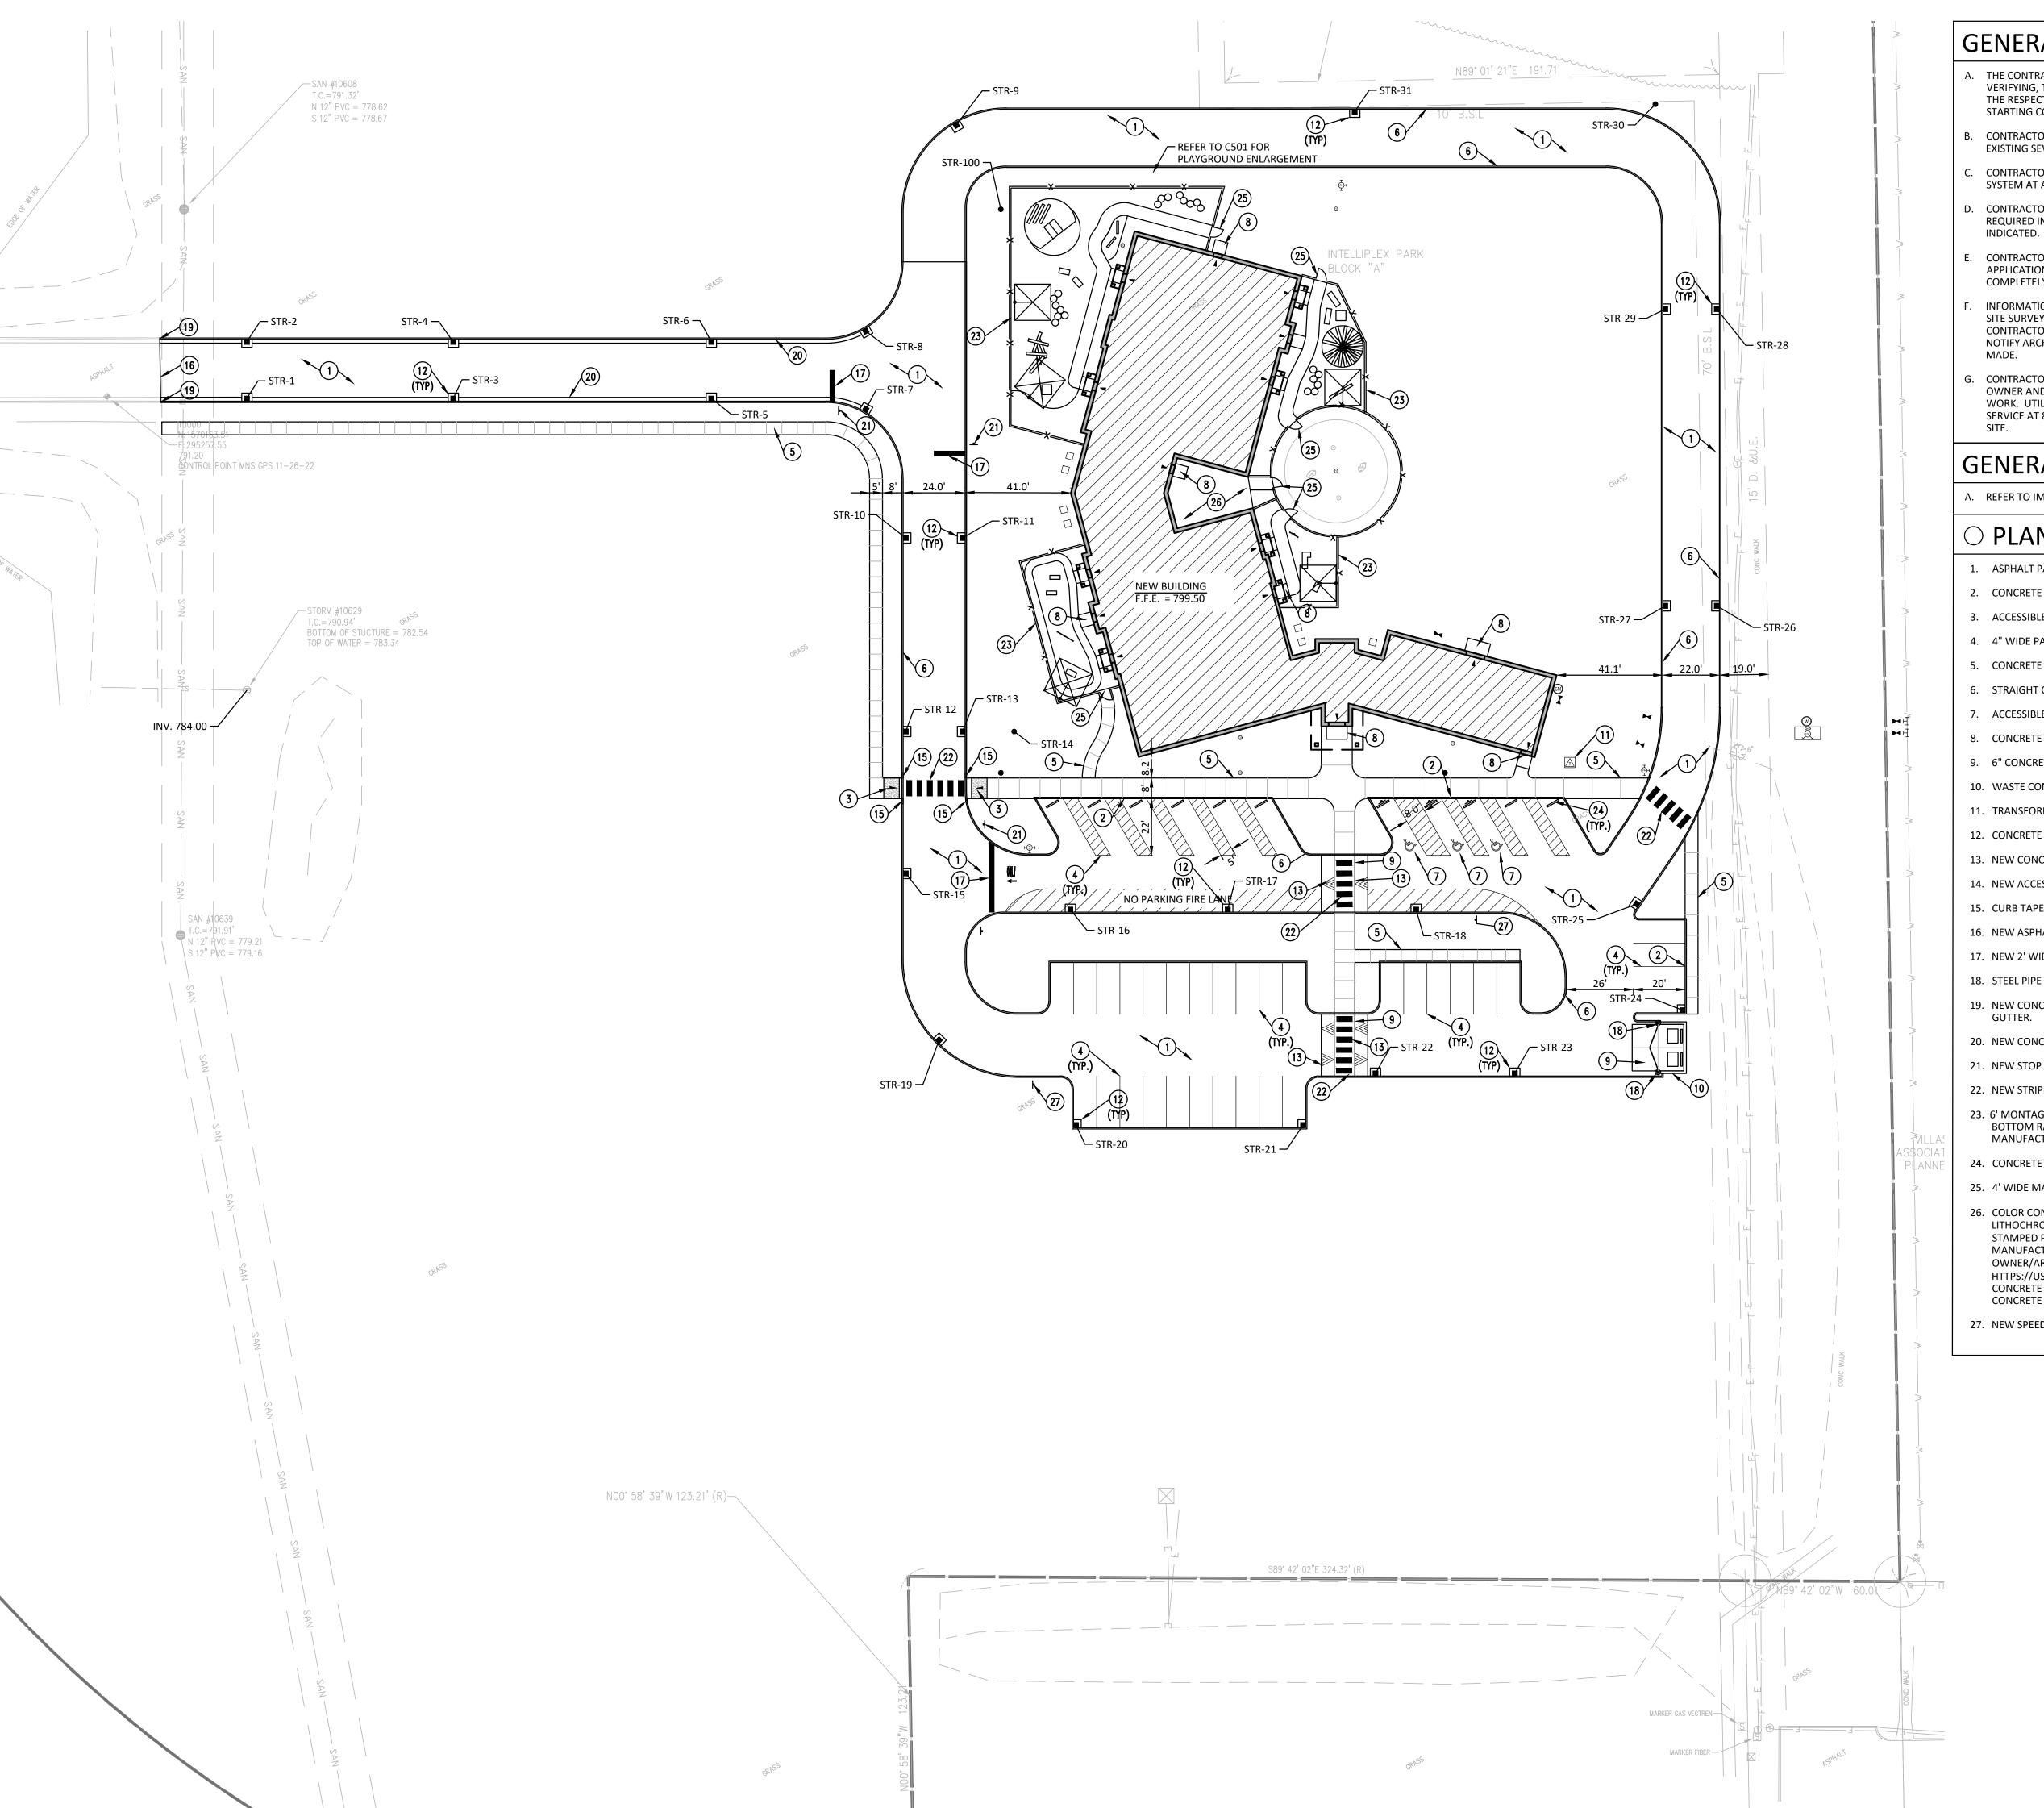

GENERAL NOTES

- A. THE CONTRACTOR SHALL BE RESPONSIBLE FOR OBTAINING, AND VERIFYING, THAT ALL PERMITS AND APPROVALS ARE OBTAINED FROM THE RESPECTIVE CITY, COUNTY, STATE AND FEDERAL AGENCIES PRIOR TO STARTING CONSTRUCTION.
- 3. CONTRACTOR SHALL VERIFY LOCATION AND INVERT ELEVATIONS OF EXISTING SEWERS PRIOR TO START OF CONSTRUCTION.

X

CONSTRUCTION

DOCUMENTS

- CONTRACTOR SHALL MAINTAIN A COMPLETE AND OPERABLE UTILITY SYSTEM AT ALL TIMES.
- CONTRACTOR SHALL INCLUDE COSTS FOR CUTTING AND PATCHING AS REQUIRED IN THEIR BID PROPOSAL TO COMPLETELY INSTALL THE WORK
- CONTRACTOR SHALL INCLUDE ALL TAP FEES, PERMIT FEES AND APPLICATION FEES IN THEIR BID PROPOSAL AS NECESSARY TO COMPLETELY INSTALL THE WORK INDICATED.
- INFORMATION SHOWN WAS OBTAINED FROM AN OWNER FURNISHED SITE SURVEY OF EXISTING CONDITIONS AND IS UNCONFIRMED. CONTRACTOR IS REQUIRED TO FIELD VERIFY THIS INFORMATION AND NOTIFY ARCHITECT OF ANY DISCREPANCIES SO MODIFICATION CAN BE
- CONTRACTOR SHALL COORDINATE EXACT UTILITY LOCATIONS WITH THE OWNER AND LOCAL UTILITY COMPANIES PRIOR TO COMMENCING ANY WORK. UTILIZE THE INDIANA UNDERGROUND UTILITY LOCATION SERVICE AT 811 OR 800-382-5544 PRIOR TO ANY EXCAVATION ON THE

GENERAL NOTES


A. REFER TO IMPROVEMENT DETAILS FOR NOTE REFERENCES.

O PLAN NOTES

- ASPHALT PAVEMENT.
- 2. CONCRETE CURB AND WALK.
- 3. ACCESSIBLE RAMP.
- 4. 4" WIDE PAINTED PARKING STRIPE.
- CONCRETE WALK.
- 6. STRAIGHT CONCRETE CURB.
- 7. ACCESSIBLE PARKING SPACE.
- 8. CONCRETE STOOP.
- 9. 6" CONCRETE PAVEMENT.
- 10. WASTE CONTAINER PAD AND ENCLOSURE.
- 11. TRANSFORMER PAD.
- 12. CONCRETE INLET COLLAR.
- 13. NEW CONCRETE SPEED TABLE.
- 14. NEW ACCESSIBLE PARKING SIGN.
- 15. CURB TAPER.
- 16. NEW ASPHALT TO EXISTING ASPHALT PAVEMENT.
- 17. NEW 2' WIDE PAINTED STOP BAR.
- 18. STEEL PIPE BOLLARD.
- 19. NEW CONCRETE CURB AND GUTTER TO EXISTING CONCRETE CURB AND
- 20. NEW CONCRETE CURB AND GUTTER.
- 21. NEW STOP SIGN.
- 22. NEW STRIPING CROSSWALK.
- 23. 6' MONTAGE MAJESTIC FENCE WITH 3 RAIL PANELS BY AMERISTAR. FLUSH BOTTOM RAIL WITH 3" PET, POOL, & PLAY PICKET AIRSPACE. INSTALL PER MANUFACTURER'S RECOMMENDATION.
- 24. CONCRETE WHEEL STOP.
- 25. 4' WIDE MAN-GATE.
- 26. COLOR CONDITIONED STAMPED CONCRETE. WITH SIKA COLOR/ LITHOCHROME COLOR HARDENER, ANTIQUING RELEASE AND SEALER. STAMPED PATTERN SELECTED BY OWNER/ ARCHITECT FROM MANUFACTURERS RANGE OF LITHOTEX STAMPS. COLOR TO BE SELECTED BY OWNER/ARCHITECT FROM MANUFACTURES FULL COLOR RANGE. WEB: HTTPS://USA.SIKA.COM/EN/CONSTRUCTION/CONCRETE/DECORATIVE-CONCRETE MULTIPLE SAMPLE PANELS MAY BE REQUIRED PER DECORATIVE CONCRETE SPECIFICATION.
- 27. NEW SPEED TABLE SIGN REFER TO DETAIL C512.

	_
PARKING TYPE	# OF SPACES
STANDARD	40
ACCESSIBLE	3
TOTAL PROVIDED	43 PHASE 1 - 93 PHASE 2
TOTAL REQUIRED -PHASE 1	96 STUDENTS =24 SPACES (43 OWNER REQUESTED MI
TOTAL REQUIRED -PHASE 2	196 STUDENTS= 48 SPACE (86 OWNER REQUESTED MI



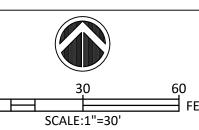



SCALE: 1" = 30' MAY 31, 2023 PROJECT #: 22JPSC83 DRAWN: CLM COORD: ADS APPROVED: ADS

SITE IMPROVEMENT

OVERALL

PLAN

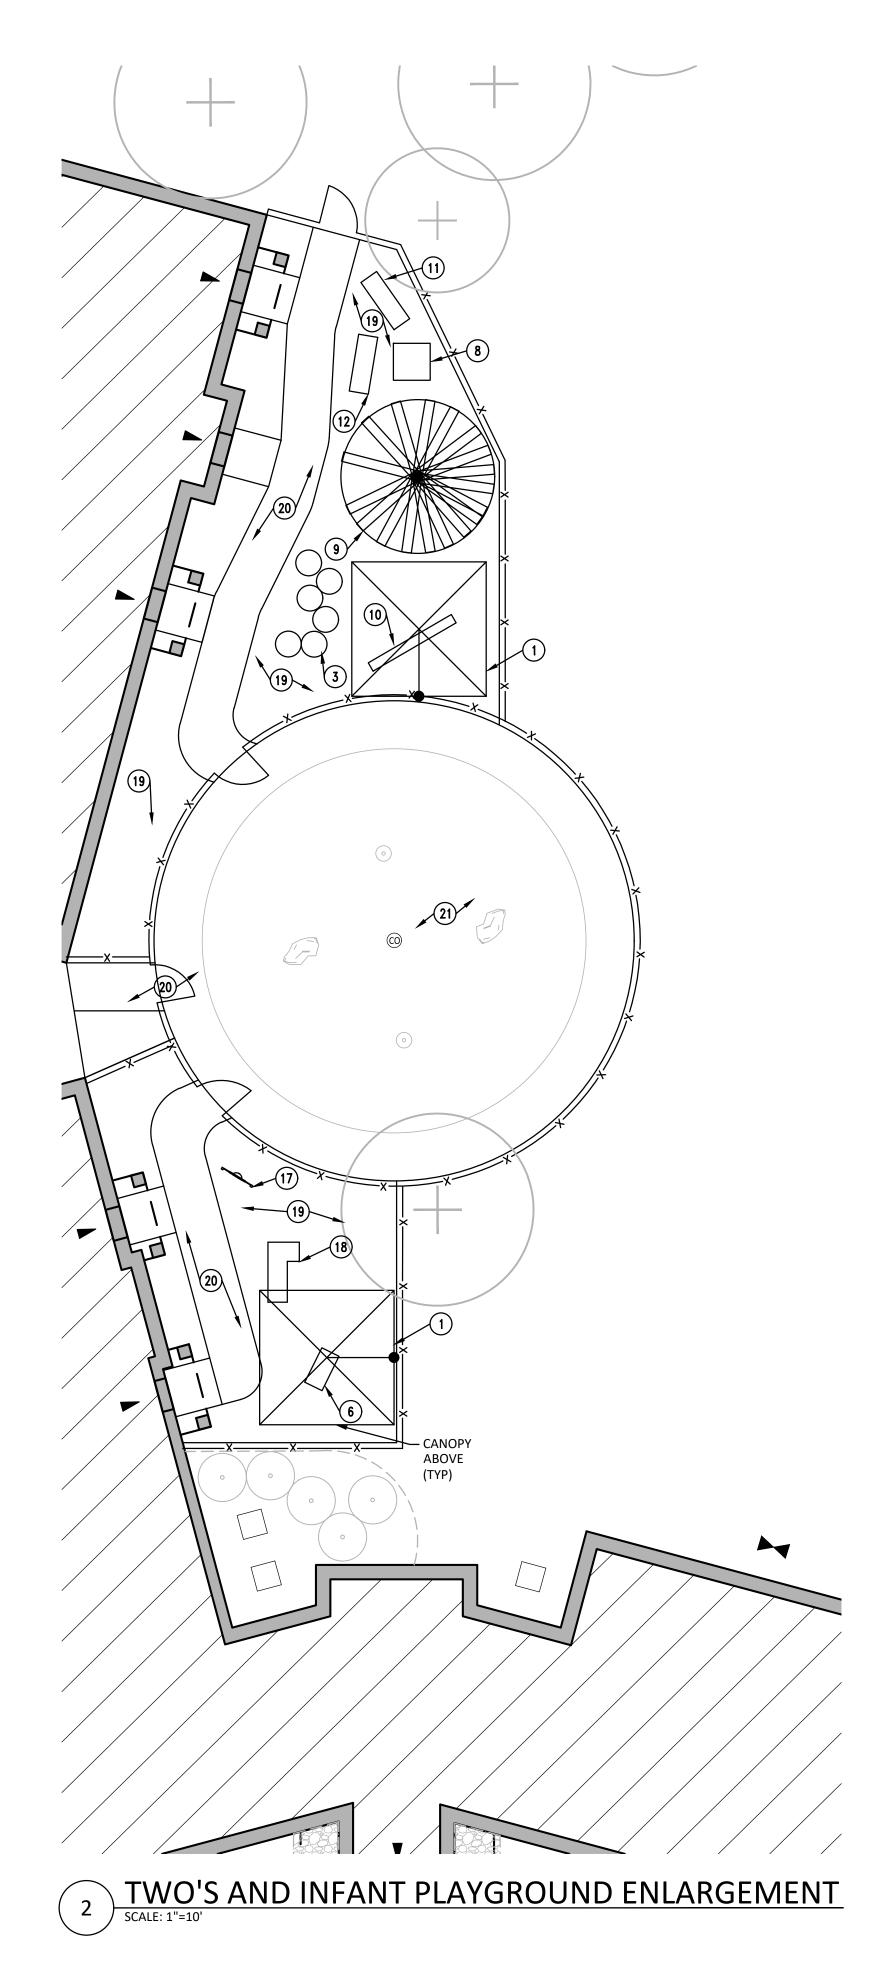

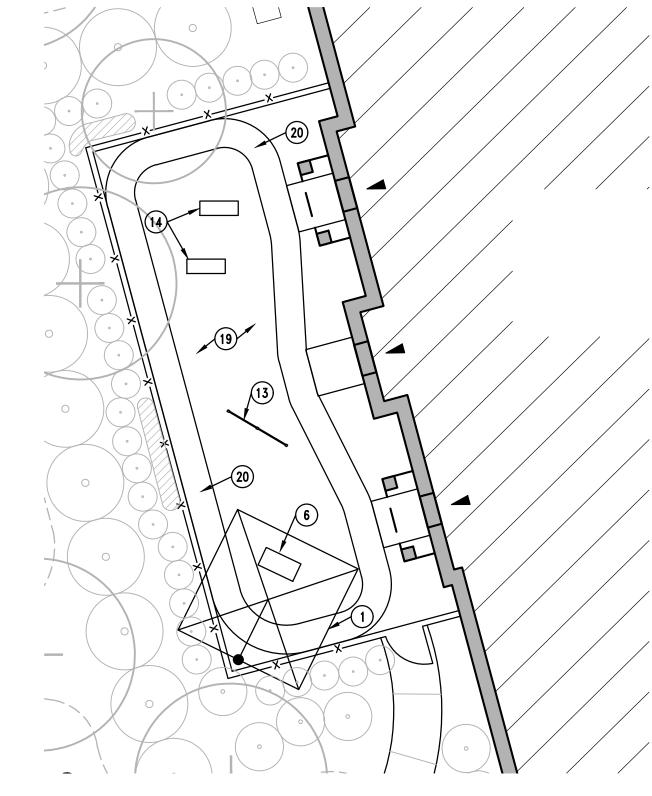

GENERAL NOTES


A. REFER TO IMPROVEMENT DETAILS FOR NOTE REFERENCES.
B. PLAYGROUND LAYER IS SCHEMATIC AND FOR COORDINATION PURPOSE ONLY. ALL EQUIPMENT LISTED TO BE PROVIDED AND INSTALLED BY EMC2.


O PLAN NOTES

- 1. 14' X 14' CANTILEVER SHADE STRUCTURE.
- 2. HILLSIDE SLIDE AND MOUND W/ ARTIFICIAL TURF.
- 3. STEPPING STUMPS.
- 6. LOG BENCHES.

- 12. CHIMES PANEL.
- 14. SENSORY BOXES GEAR/ SLIDE N SLOT.
- 15. OPTIGEAR PANEL.
- 16. MARBLE PANEL.
- 17. FUN MIRROR.
- 18. BUTTERFLY HILL. 19. ARTIFICIAL TURF.
- 20. PIP RUBBER PLAY SURFACE DEPTH BASED ON MAX FALL HEIGHT. COLOR TO BE SELECTED BY OWNER /ARCHITECT FROM MANUFACTURE FULL COLOR RANGE.
- 21. WATER PLAY AREA CONCRETE/ PIP RUBBER.



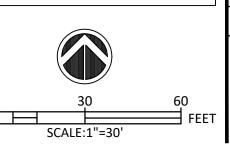

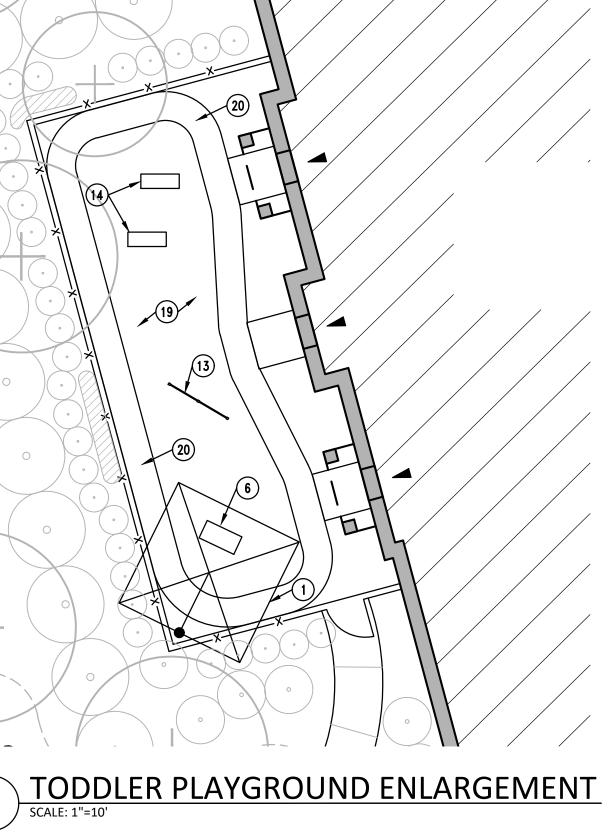

- 4. VERTICAL LOGS FOR STEPS ON SIDE OF HILLSIDE.
- LOG SCRAMBLE.
- 7. MAGNETIC CHALKBOARD PANELS.
- 8. SAND TABLES.
- 9. TEE PEE 10" HT. -8 ' DIAMETER.
- 10. BALANCE LOG.
- 11. MUSICAL FENCE.
- 13. TODDLER PULL UP BAR.




CONSTRUCTION

DOCUMENTS

PLAYGROUNDS IMPROVEMENT PLAN SCALE: 1" = 30' MAY 31, 2023

DRAWN: CLM COORD: ADS APPROVED: ADS

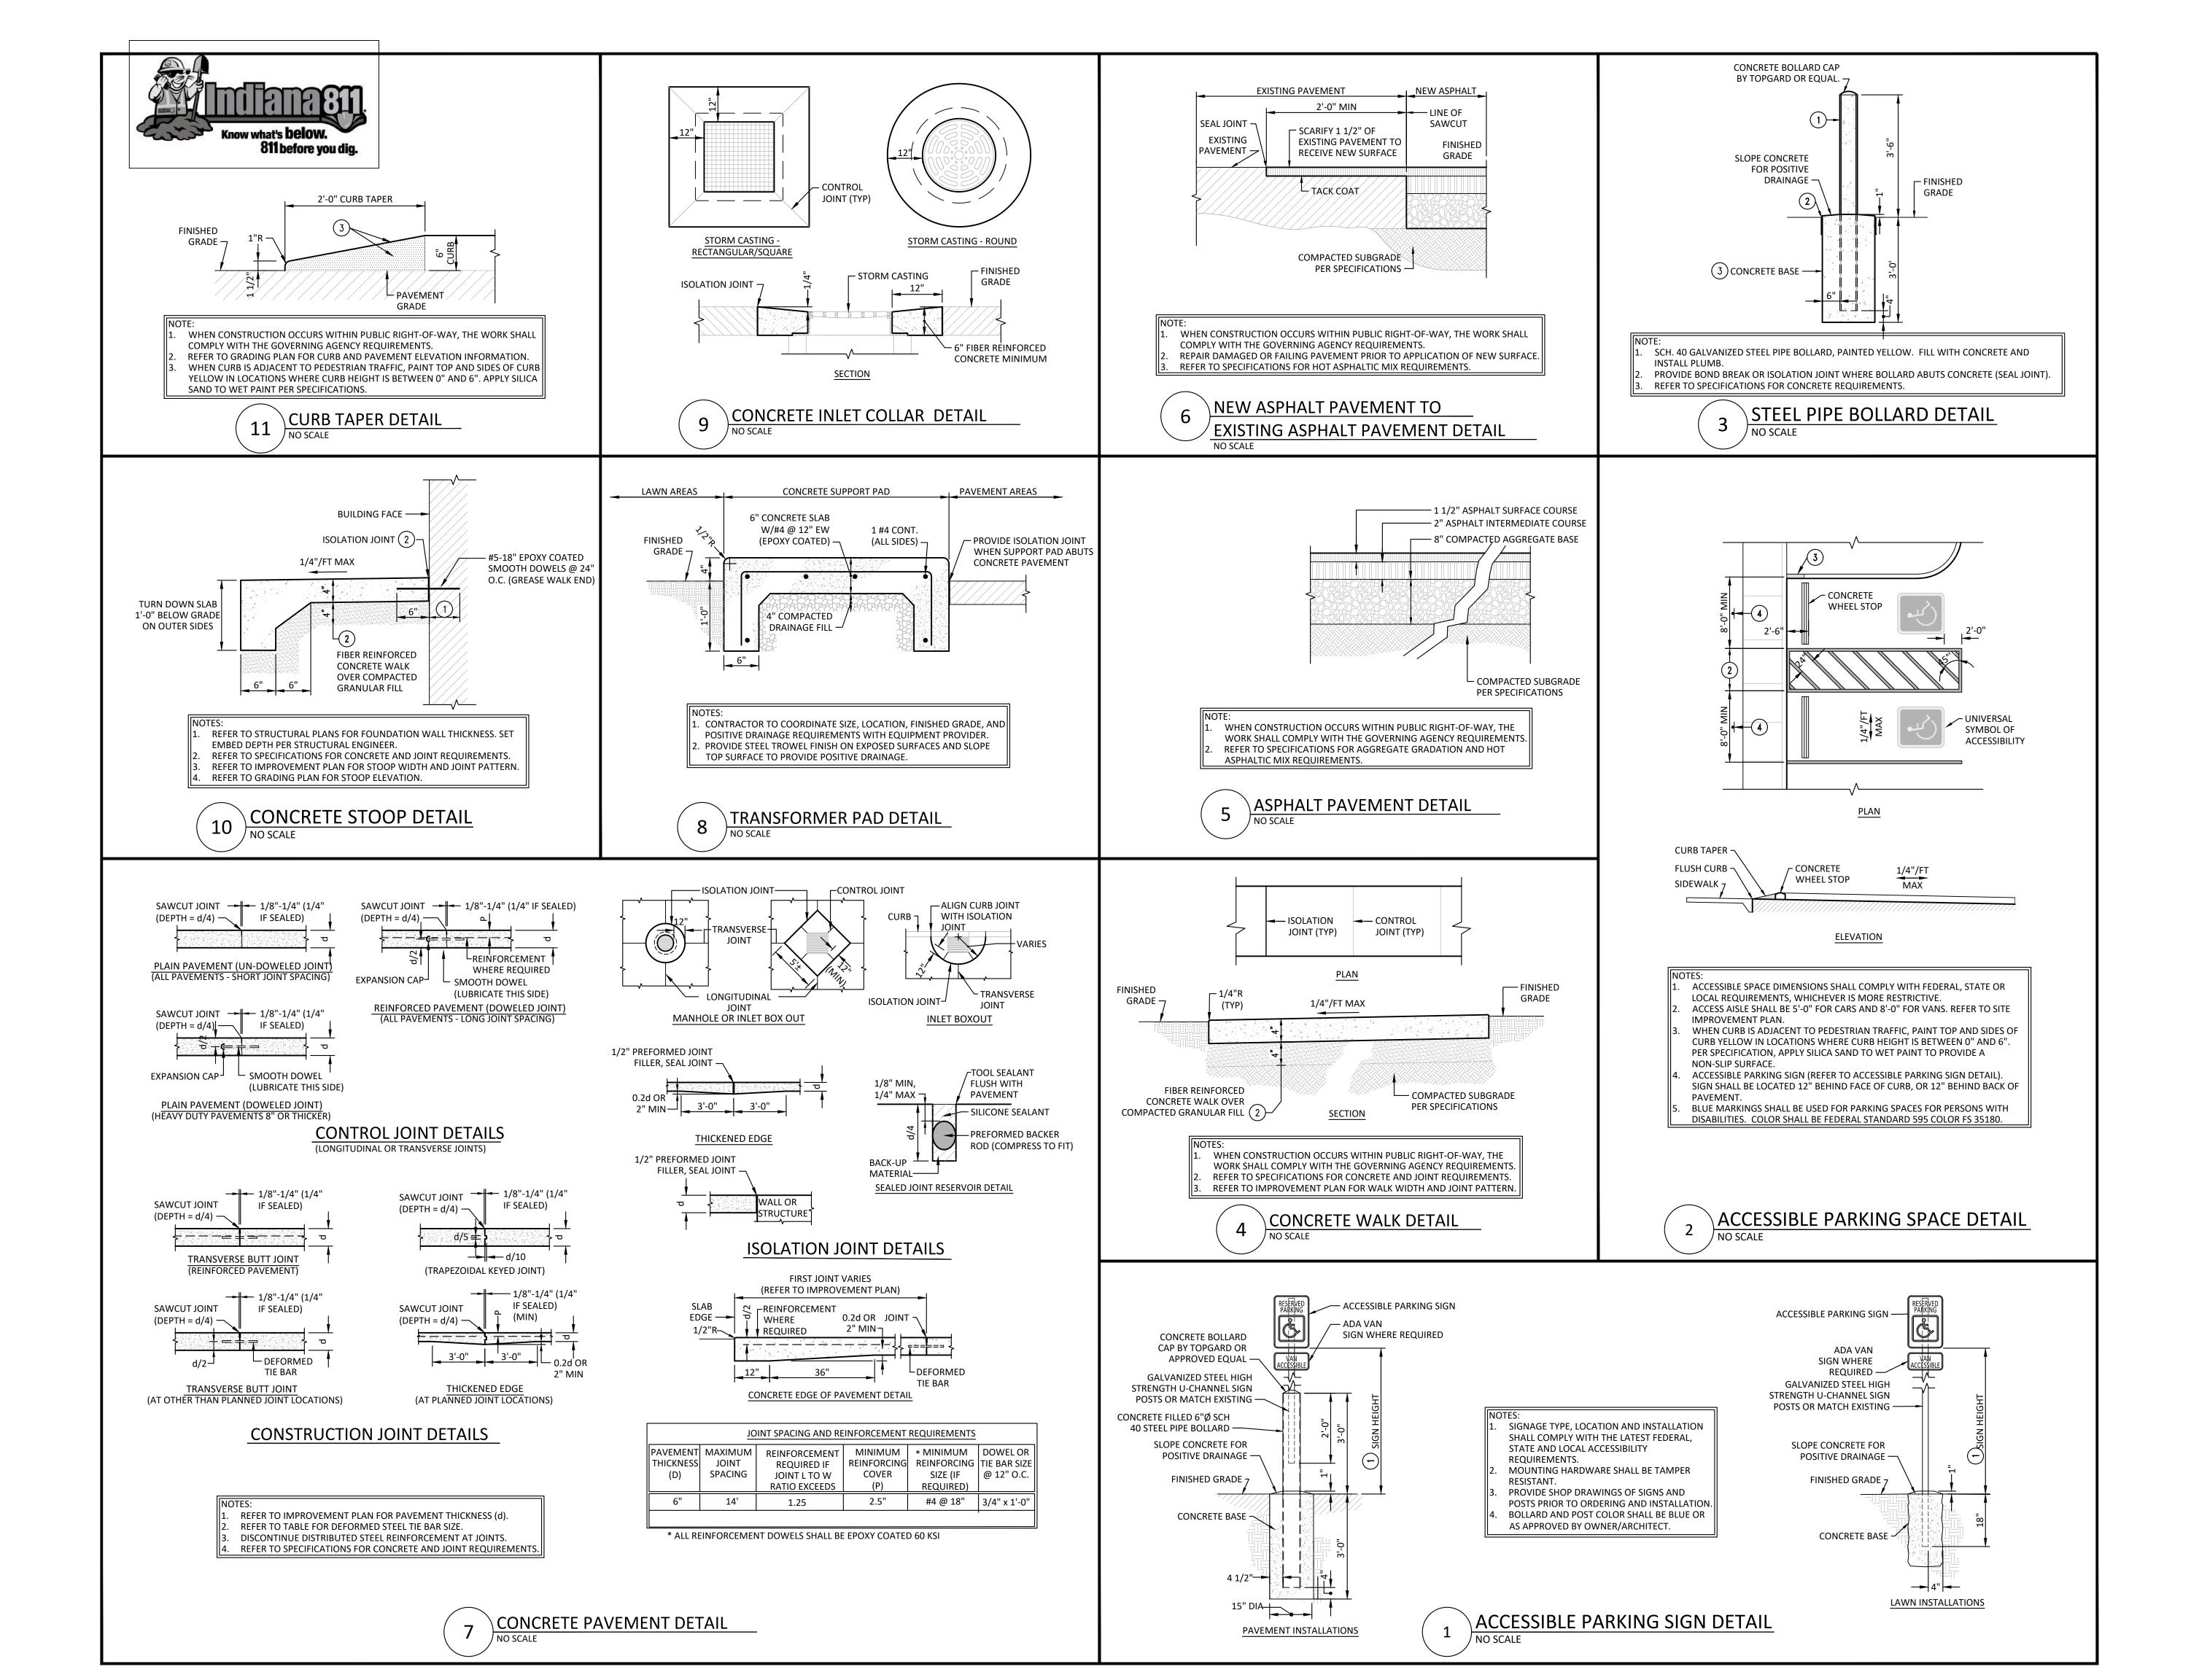



ONSULTIN GINEERS,1

9365 Counselors Row, S Indianapolis, IN 46240 ph 317.617.4270

NNEBOHM EARLY ARNING CENTER

CONSTRUCTION DOCUMENTS

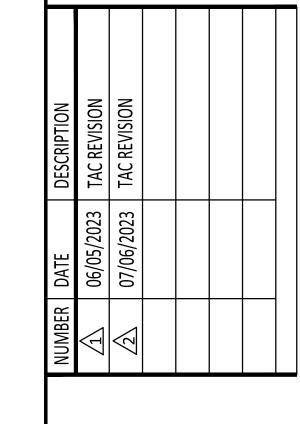

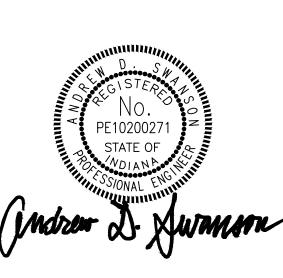

SITE IMPROVMENT DETAILS

 SCALE:
 1" = 30'

 DATE:
 MAY 31, 2023


 PROJECT #:
 22JPSC83

 DRAWN:
 CLM

 COORD:
 ADS

C510

APPROVED: ADS

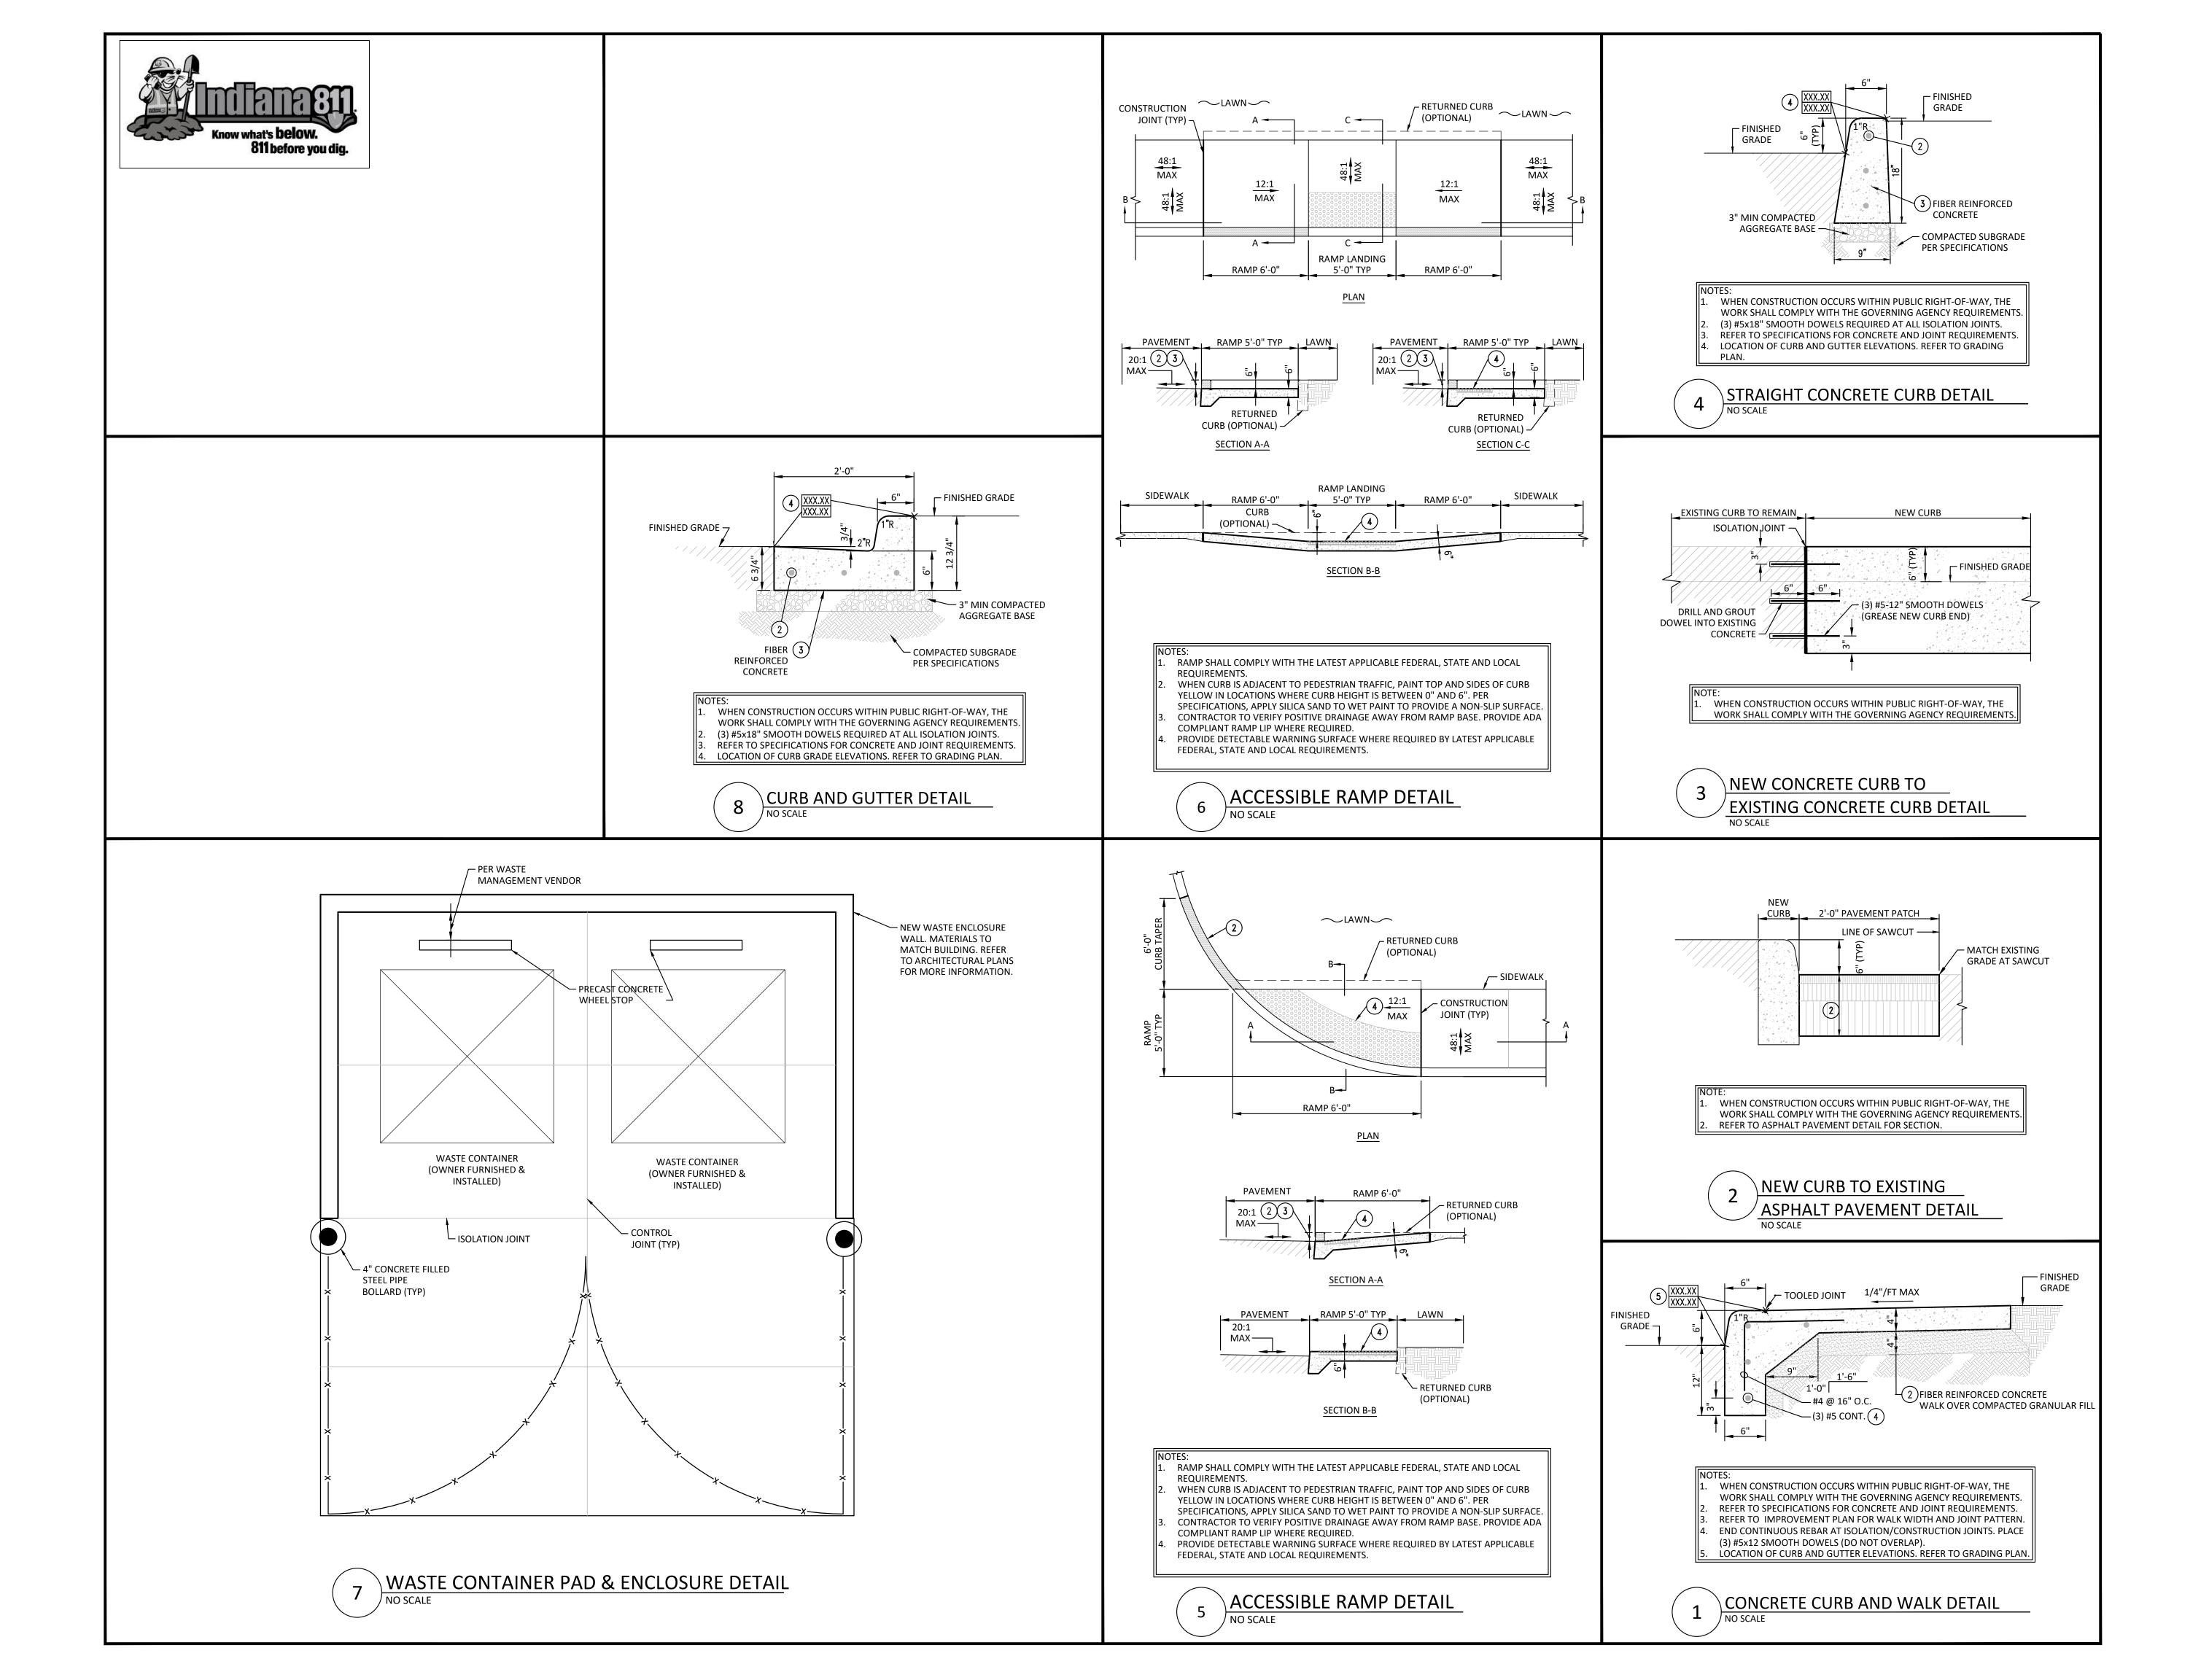



ONSULTIN NGINEERS, In 46240

 $\mathbf{JFS} \, \mathbf{E} \, \mathbf{N} \, \mathbf{G} \, \mathbf{I}$ 9365 Counselors Row Indianapolis, IN 4624

NNEBOHM EARLY FARNING CENTER

CONSTRUCTION DOCUMENTS

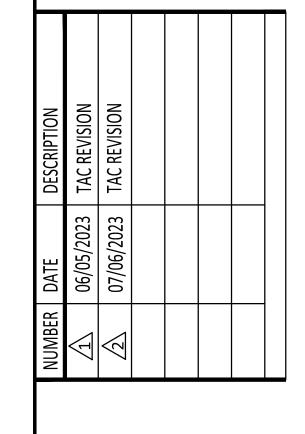

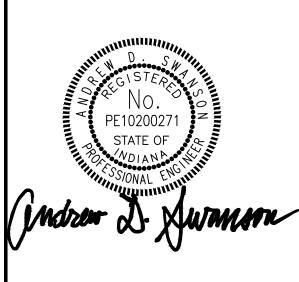


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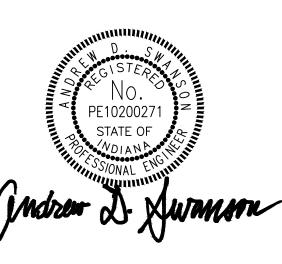
SCALE:	1" = 30'
DATE:	MAY 31, 2023
PROJECT #:	22JPSC83
DRAWN:	CLM
COORD:	ADS
APPROVED:	ADS

CONSULTIN ENGINEERS Counselors Row, Suite 116 7.617.4270

JULIA & NICHOLAS UNNEBOHM EARL LEARNING CENTER


CONSTRUCTION DOCUMENTS




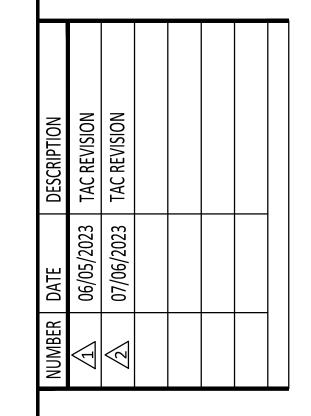

SITE IMPROVMENT DETAILS

SCALE:	1" = 30'	
DATE:	MAY 31, 2023	
PROJECT #:	22JPSC83	
DRAWN:	CLM	
COORD:	ADS	
APPROVED:	ADS	

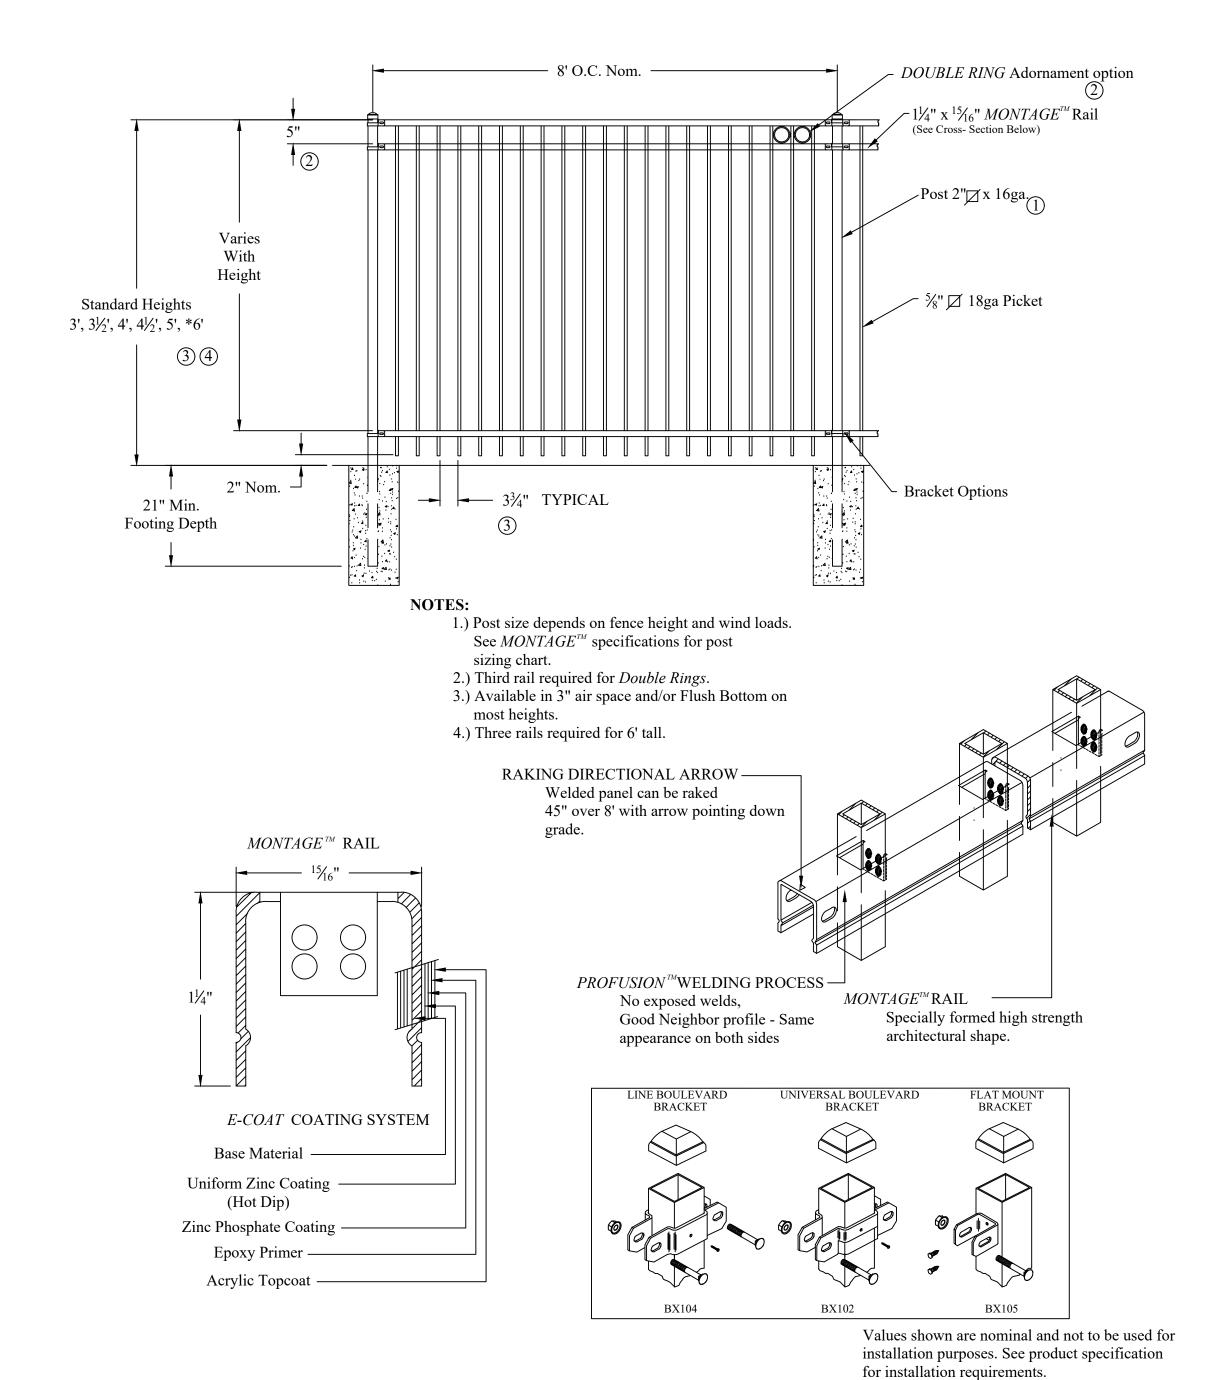

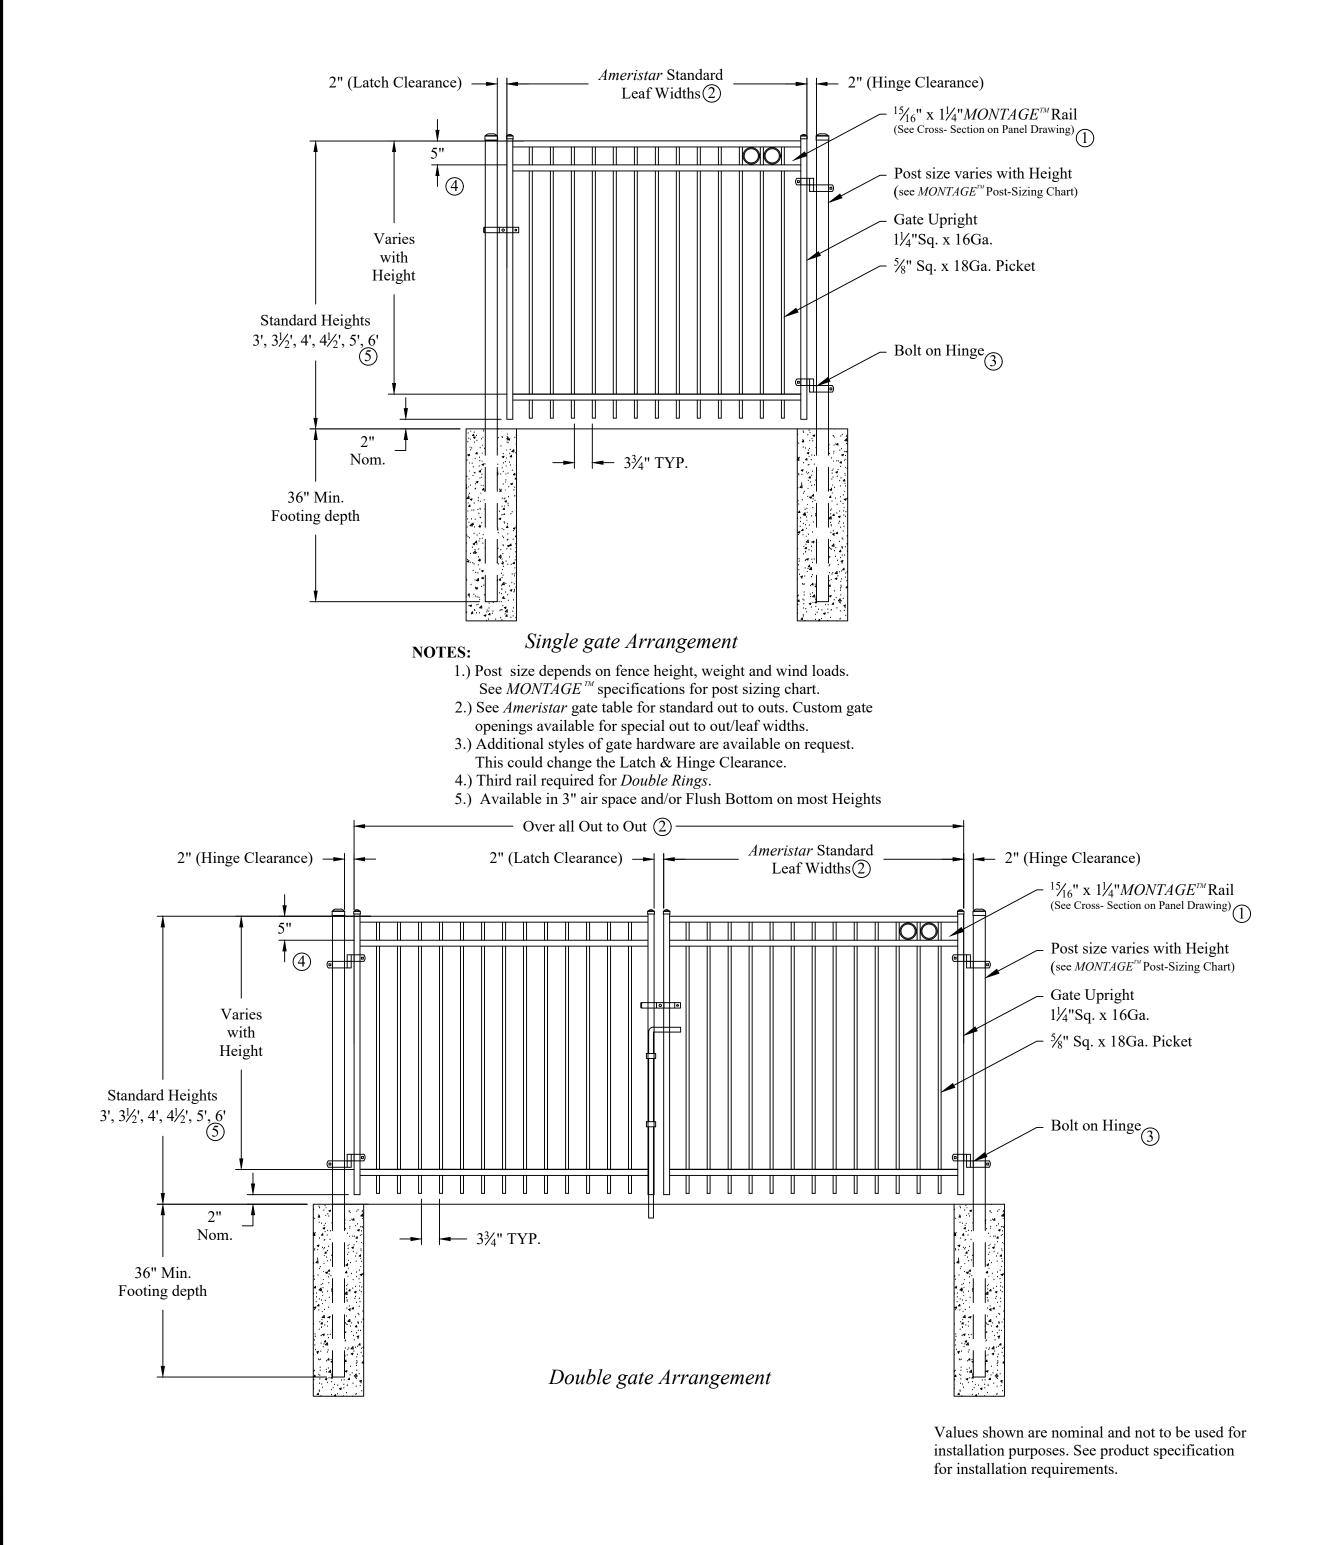

2 MONTAGE MAJESTIC FENCE DETAIL
NO SCALE


1 MONTAGE MAJESTIC GATE DETAIL
NO SCALE

CONSULTIN ENGINEERS,1

OHM EARLY

JG CENTER

CONSTRUCTION DOCUMENTS

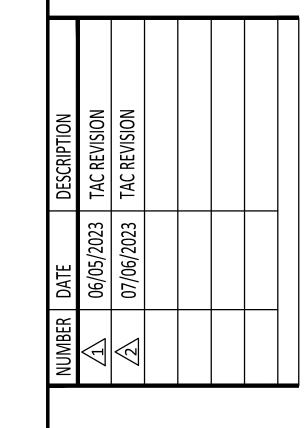





SITE IMPROVMENT DETAILS

SCALE:	1" = 30'
DATE:	MAY 31, 2023
PROJECT #:	22JPSC83
DRAWN:	CLM
COORD:	ADS

APPROVED: ADS

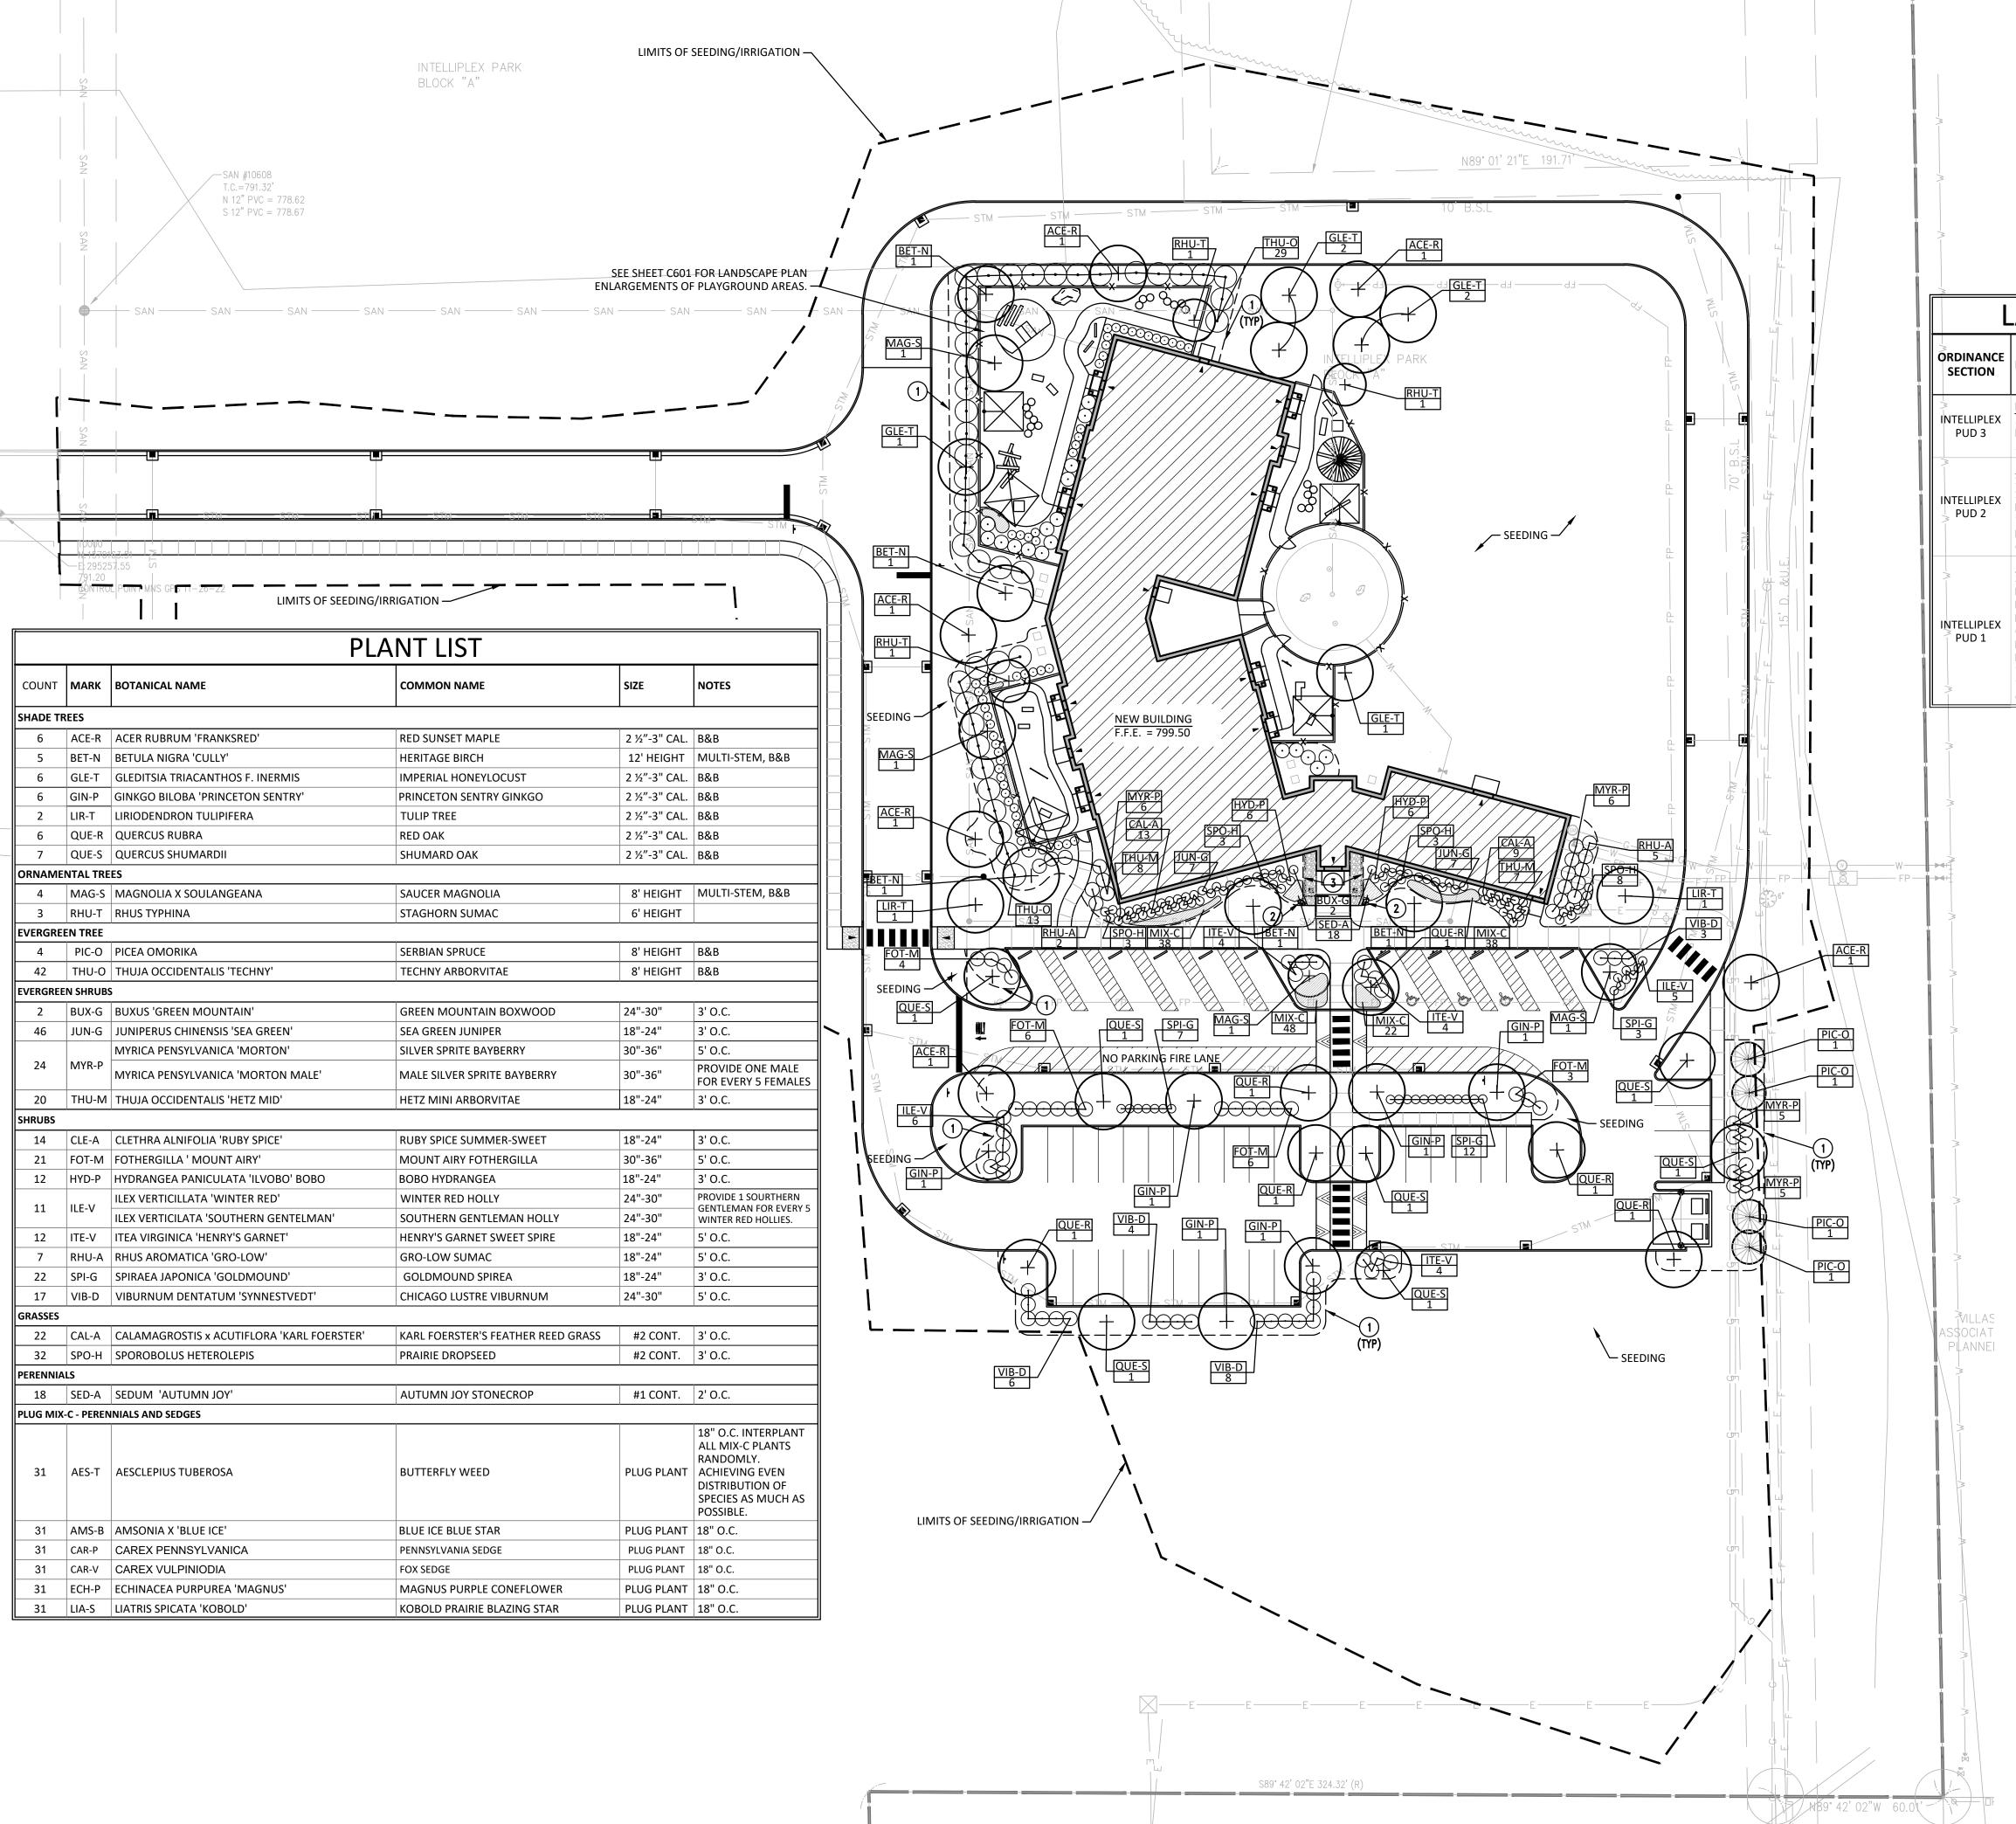

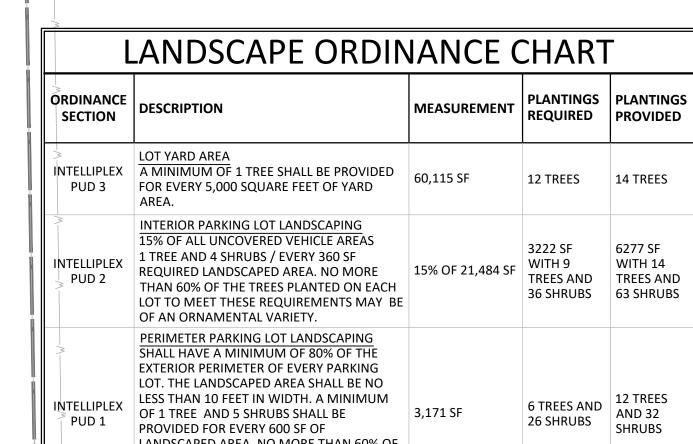

LANDSCAPED AREA. NO MORE THAN 60% OF THE TREES PLANTED ON EACH LOT TO MEET THESE REQUIREMENTS MAY BE OF AN ORNAMENTAL VARIETY.

GENERAL NOTES

- A. REFER TO LANDSCAPE DETAILS FOR NOTE REFERENCES.
- B. ALL DISTURBED LAWN AREAS TO BE SEEDED UNLESS OTHERWISE
- C. CONTRACTOR TO SUBMIT IRRIGATION DRAWINGS FOR REVIEW.

O PLAN NOTES

- SPADE EDGE.
- BOULDER.
- 3. STONE MULCH & METAL EDGE.

CONSTRUCTION **DOCUMENTS**




SITE LANDSCAPE PLAN

SCALE:	1" = 30"
DATE:	MAY 31, 2023
PROJECT #:	22JPSC83
DRAWN:	TPJ
COORD:	ADS

APPROVED: RKF

PLAN NOTES1. SPADE EDGE.2. BOULDER.

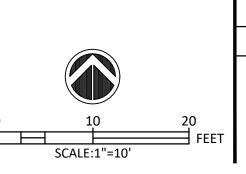

JULIA & NICHOLAS UNNEBOHM EARL LEARNING CENTER

CONSTRUCTION DOCUMENTS

DESCRIPTION	TAC REVISION	TAC REVISION		
DATE	06/05/2023	07/06/2023		
NUMBER DATE	\bigvee	$\nabla \!$		



PLAYGROUNDS LANDSCAPE PLAN

SCALE:	1" = 10'
DATE:	MAY 31, 2023
PROJECT #:	22JPSC83
DRAWN:	TPJ
COORD:	ADS
	DATE: PROJECT #: DRAWN:


APPROVED: RKF

C601

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> LIA & NICHOLAS NNEBOHM EARLY ARNING CENTER

CONSTRUCTION DOCUMENTS



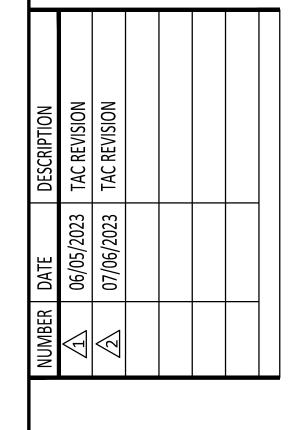

SITE LANDSCAPE DETAILS

SCALE: AS NOTED

DATE: MAY 31, 2023

PROJECT #: 22JPSC83

DRAWN: TPJ

COORD: ADS

APPROVED: RKF



NICK & JULIA RUNNEBOHM EARLY LEARNING CENTER

SHELBYVILLE, INDIANA

APRIL 17, 2023 | PROJ #1951



